


BUILDERS SHALL VERIFY ALL DIMENSIONS AND ALL JOB SITE CONDITIONS PRIOR TO PROCEEDING WITH CONSTRUCTION AND REPORT ANY DISCREPANCIES IMMEDIATELY TO THE ARCHITECT.

ONLY THE LATEST APPROVED DRAWINGS ARE TO BE USED FOR CONSTRUCTION.

IT IS THE BUILDER'S DUTY TO ENSURE THAT THEY HAVE THE LATEST APPROVED DRAWINGS IN HAND.

PROJECT  
NORTH

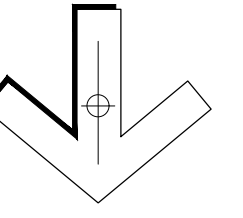


These architectural drawings are the property of Peter Higgins Architect Inc. 1560 Bayview Avenue, Suite 302, Toronto, Ontario.

In consideration for full payment of the architectural services rendered, the use of these drawings and any supporting attachments is granted to the client/agency responsible for the construction of the forementioned titled project, as designed, depicted and detailed on these drawings.

These architectural drawings shall not be reproduced or used for any other purpose at any other address by any other person, firm or corporation without the written consent of Peter Higgins Architect Inc.

SEE DRAWING A-1 FOR GENERAL AND CONSTRUCTION NOTES

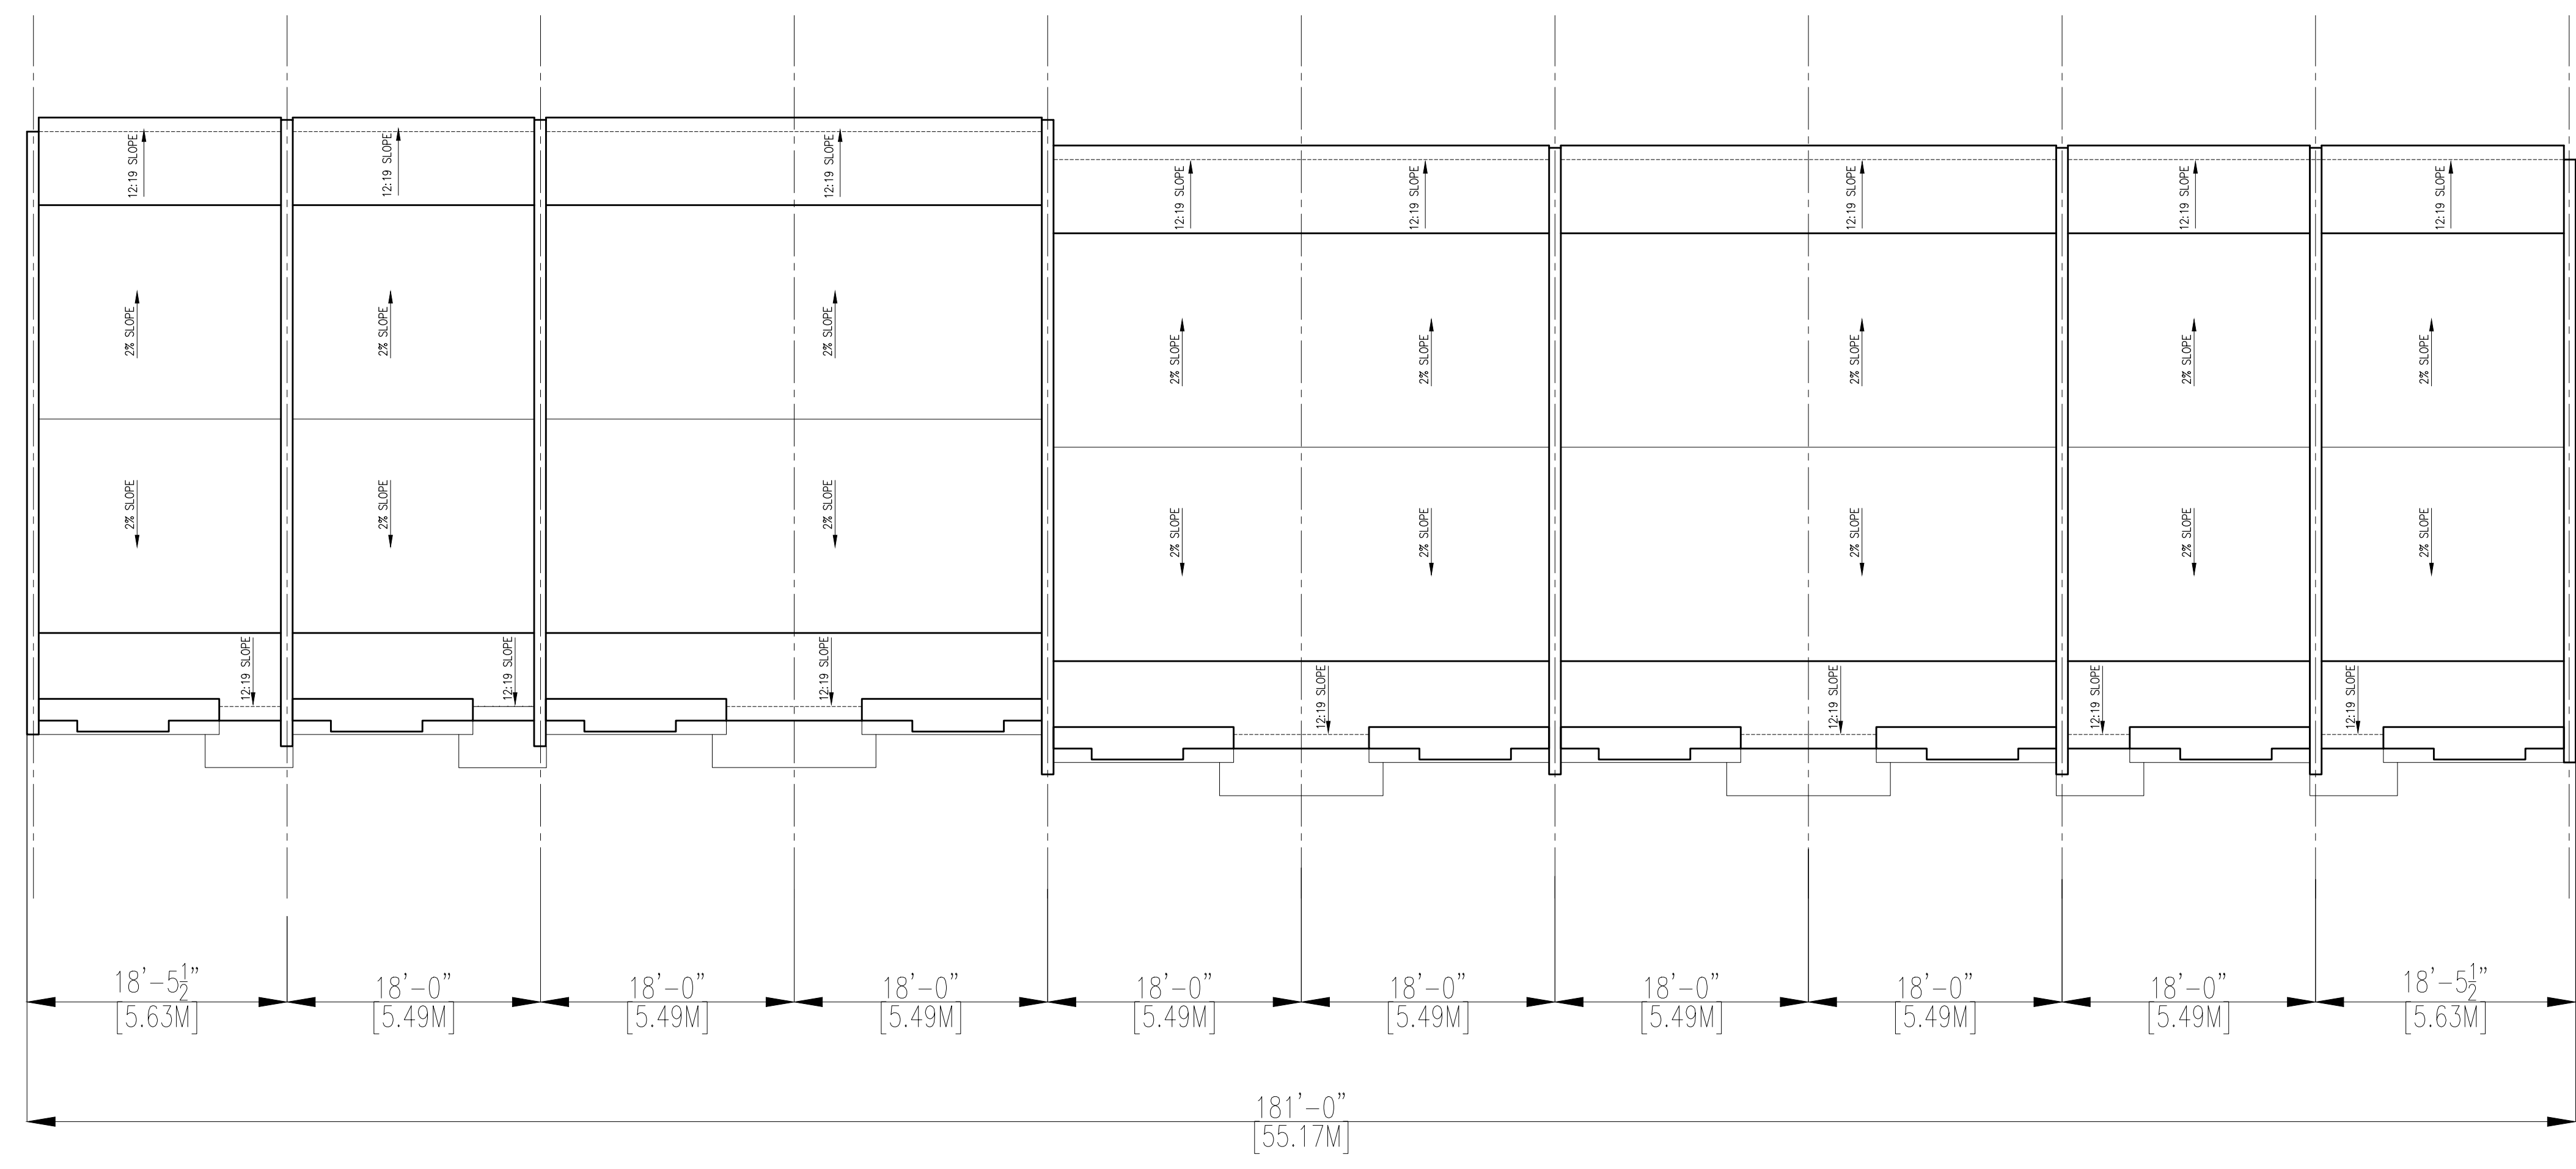

NO.	DATE	DESCRIPTION
13	JULY 08, 19	FLOOR PLANS/ELEVATIONS ISSUED
12	JUNE 27, 19	REVISE SITE PLAN
11	APR 22 2019	REVISE SITE PLAN
10	MAR 18 2019	REVISE BLOCK C
9	MAR 15 2019	REVISED FOR CLIENT REVIEW
8	FEB 27 2019	REVISED FOR CLIENT REVIEW
7	JAN 23 2019	REVISED FOSTER DR - FOR CLIENT REVIEW
6	JAN 11 2019	REVISED FOR CLIENT REVIEW
5	MAR 22 2018	REVISED FOR CLIENT REVIEW
4	MAR 5 2018	REVISED FOR CLIENT REVIEW
3	JAN 25 2018	REVISED FOR CLIENT REVIEW
2	JAN 3 2018	REVISED FOR CLIENT REVIEW
1	MAY 4 2017	ISSUED FOR PRE-CONSULTATION REVIEW

REVISIONS / ISSUE DATES

**HIGGINS** **PETER HIGGINS ARCHITECT INC.**  
 124 MERTON STREET, SUITE 204  
 TORONTO, ONTARIO, M4S 2Z2  
 OFFICE: (416) 481-6229  
 FAX: (416) 481-8084  
 E-MAIL: phigginsarchitect@rogers.com

PROJECT:  
**237 FOSTER DR - 428 LITTLE AVE**  
BARRIE, ONTARIO  
BLOCK C

DRAWN BY: L.B.M.S.A  
DATE: MAY 2017

CHECKED BY: P.J.H.

SCALE: 1:100  
BCIN 4208 3486

PROJECT NO: 17-023  
DRAWING TITLE: ROOF PLAN  
DRAWING NO: A-5