### NOTES FOR SEDIMENT & EROSION CONTROL

- DISTURBED AREAS THAT HAVE FAILED TO HAVE STABLE GROUND COVER ESTABLISHED BY OCTOBER 30TH SHALL BE PROTECTED WITH A SILTATION CONTROL FENCE OR STRAW MULCH ETC. AND MAINTAINED BY THE CONTRACTOR UNTIL VEGETATION BECOMES ESTABLISHED IN THE SUBSEQUENT GROWING SEASON.
- ANY DEWATERING WASTE SHALL BE DISCHARGED TO A VEGETATED AREA AT LEAST 30 M FROM ANY WATERCOURSE AND FILTERED. FILTERING METHODS MUST BE APPROVED BY THE SITE ADMINISTRATOR.
- 3. SILT FENCE SHALL BE PUT IN PLACE PRIOR TO AND MAINTAINED DURING ALL GRADING. SILT FENCE SHALL COMPLY WITH OPSD 219.110 FOR LIGHT DUTY AND / OR OPSD 219.130 FOR HEAVY DUTY; UNLESS NOTED OTHERWISE. SILT FENCE TO BE INSPECTED PRIOR TO COMMENCEMENT OF EARTH GRADING ACTIVITIES. SILT FENCE TO BE INSPECTED AND REPAIRED OR REPLACED IF DAMAGED AS DIRECTED BY THE SITE ADMINISTRATOR. SILT CONTROLS TO BE INSPECTED ON A REGULAR BASIS AND AFTER EVERY RAIN EVENT. INSTALLATION SHALL BE TO THE MANUFACTURER'S SUGGESTED SPECIFICATIONS.
- 4. THE CONTRACTOR SHALL BE PREPARED FOR UNEXPECTED CONDITIONS AND ACCORDINGLY HAVE STOCKPILED MATERIALS ON SITE FOR NECESSARY REPAIRS AS A RESULT OF FAILED OR INADEQUATE CONTROL MEASURES. ALL SEDIMENT AND EROSION CONTROL MEASURES SHALL BE INSPECTED AT LEAST ONCE A WEEK, AND AFTER EVERY
- MUD MATS WHERE CONSTRUCTION TRAFFIC ENTERS OR LEAVES THE SITE SHALL BE USED. MUD MATS TO BE 300mm IN DEPTH, 5.0m WIDE BY 20.0m LONG, FIRST 10.0m TO 150mmø CLEAR STONE WITH THE REMAINING 10.0m CONSISTING OF 50mmø CLEAR STONE; OR MEET MUNICIPAL STANDARDS WHERE IDENTIFIED.
- CONTRACTOR SHALL OBTAIN A CURRENT COPY AND BECOME FAMILIAR WITH OPSS 805, CONSTRUCTION SPECIFICATION FOR TEMPORARY EROSION AND SEDIMENT CONTROL MEASURES AS WELL AS ALL APPLICABLE MUNICIPAL STANDARDS.
- . THE CONTRACTOR MAY CONSIDER ALTERNATIVE SEDIMENT AND EROSION CONTROL MEASURES. SUCH MEASURES SHOULD BE PRESENTED IN WRITING FOR APPROVAL OF THE SITE ADMINISTRATOR AND MUST BE APPROVED IN WRITING BY THE CONSERVATION AUTHORITY.
- 8. THE TOPS OF ALL FILTER FABRIC MUST BE A MINIMUM OF 1.0 METRES ABOVE THE GROUND LEVEL AND ATTACHED TO THE FENCE WITH A CONTINUOUS STEEL WIRE.


  ALTERNATIVELY, THE FILTER FABRIC MUST BE FOLDED OVER THE TOP OF THE FENCE AND ATTACHED TO THE FENCE WITH WIRE LOOPED THROUGH THE FABRIC ON BOTH SIDES OF THE FENCE. FILTER FABRIC IS TO BE TERRAFIX 270R OR EQUIVALENT.
- 9. ALL DISTURBED GROUND LEFT INACTIVE SHALL BE STABILIZED BY SEEDING, SODDING, MULCHING, OR COVERING OR OTHER EQUIVALENT CONTROL MEASURES. THIS PERIOD OF INACTIVITY SHALL BE AT THE DISCRETION OF THE MUNICIPAL DIRECTOR OF ENGINEERING BUT SHALL NOT EXCEED (30) DAYS OR SUCH LONGER PERIOD DEEMED ADVISABLE BY THE MUNICIPAL DIRECTOR OF ENGINEERING.
- 10. CONTRACTOR SHALL INSTALL AND MAINTAIN CATCHBASIN SEDIMENT BARRIERS THROUGHOUT THE SITE DURING ALL CONSTRUCTION ACTIVITIES IN ORDER TO MITIGATE SEDIMENT ENTERING THE STORM STORM SEWERS.
- 11. NO FUEL TO BE STORED ON SITE. IN CASE OF A SPILL PLEASE CONTACT: MOECC SPILLS ACTION CENTER 1-800-268-6060.
- 12. SEDIMENT CONTROLS ARE TO REMAIN IN PLACE UNTIL WRITTEN DIRECTION IS RECEIVED FROM THE ENGINEER REGARDING THEIR REMOVAL.
- 13. EROSION AND SEDIMENT CONTROLS WILL BE INSPECTED ON AS PER MUNICIPAL REQUIREMENTS OR AFTER SIGNIFICANT RAINFALL EVENTS

### SEQUENCE OF CONSTRUCTION


- 1. ENGINEER TO BE NOTIFIED PRIOR TO INITIATION OF ANY ON SITE WORKS. 2. SILT FENCE AND CONSTRUCTION ACCESS MATS TO BE INSTALLED PRIOR TO THE COMMENCEMENT OF ANY WORKS ONSITE.
- 3. VEGETATION REMOVAL MAY COMMENCE AFTER ALL SILT FENCE IS INSTALLED AND APPROVED BY THE ENGINEER.
- 4. COMMENCE WITH EARTH EXCAVATION AND SITE SERVICING (TO BE REMOVED FROM SITE - NO STOCKPILE).
- 5. EROSION CONTROL MEASURES TO BE MAINTAINED AS DIRECTED BY THE ENGINEER DURING THE CONSTRUCTION PERIOD. ADDITIONAL CONTROL MEASURES MAY BE REQUIRED AT THE DISCRETION OF THE ENGINEER.
- 6. ALL DISTURBED GROUND LEFT INACTIVE FOR MORE THAN 30 DAYS SHALL BE STABILIZED WITH SEED, SOD, MULCH OR OTHER ADEQUATE COVERING, AS INSTRUCTED BY THE ENGINEER.
- 7. ALL CONSTRUCTION VEHICLES TO ACCESS THE SITE VIA THE DESIGNATED CONSTRUCTION ENTRANCES AS SHOWN.

---- FLOOD LINE

	Site Area Area of Alteration	1400 sq.m. 1400 sq.m.
ı	Existing Land Use	RESIDENTIAL (R1
1	Adjoining Property Land Use	RESIDENTIAL
	Soil Type	SANDY LOAM (D

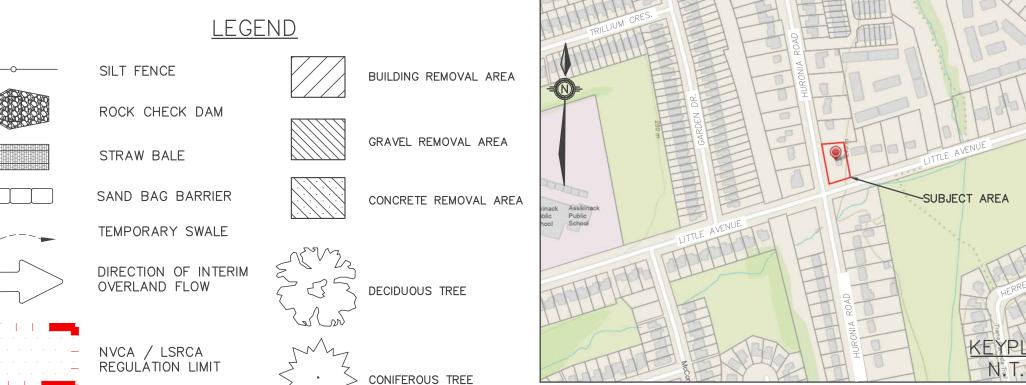



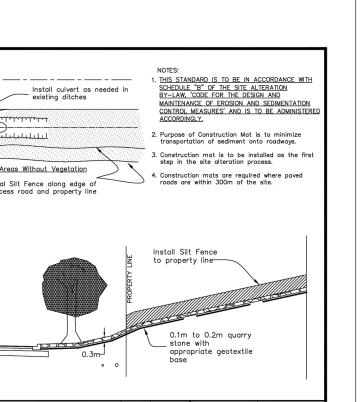

YY/MM/DD Issuance Description ZONING BY-LAW AMENDMENT

222 Mapleview Drive West, Suite 300 Barrie, ON L4N 9E7 Canada

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Fax.: F.705.737.1772

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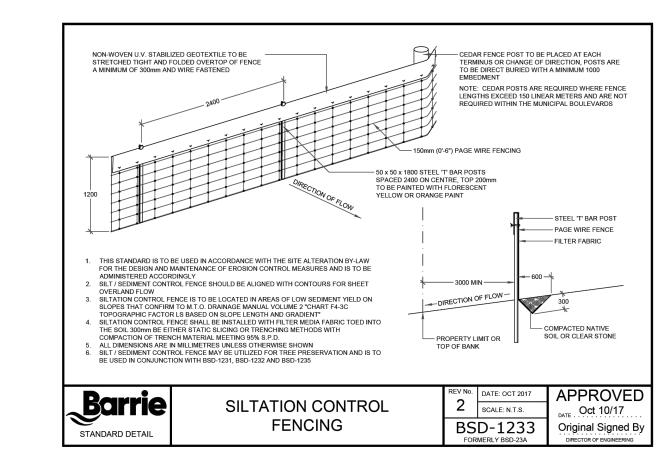
0 5 10 20 30 40 50mm 


0" 1/4" 1/2" 1" 1 1/2" 2"

by the design engineer's initials.

Do not scale drawings.

Areas Without Vegetation Dual Silt Fence along edge of access road and property line Standardized Dimension Text J.S. 05.10.28 APR'D: R.G.N. DATE: 04.03. CONSTRUCTION ENTRANCE MAT BSD-23D REVISION



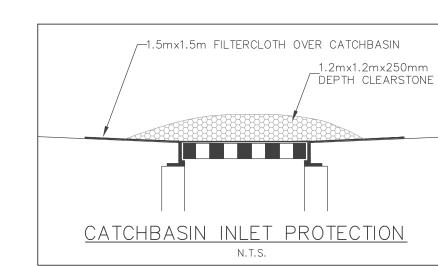



NJ ELECTRIC GENERAL CONTRACTING 182 BIRKSHIRE DRIVE, AURORA, ON L4G 7R8

Project PROPOSED TOWNHOUSE DEVELOPMENT


159 HURONIA ROAD, BARRIE,ON

EROSION & SEDIMENT CONTROL REMOVALS PLAN

484-032-22 Designed by: IO Checked by: KF Drawn by: IO Approved by:ES



ESC-RM-1

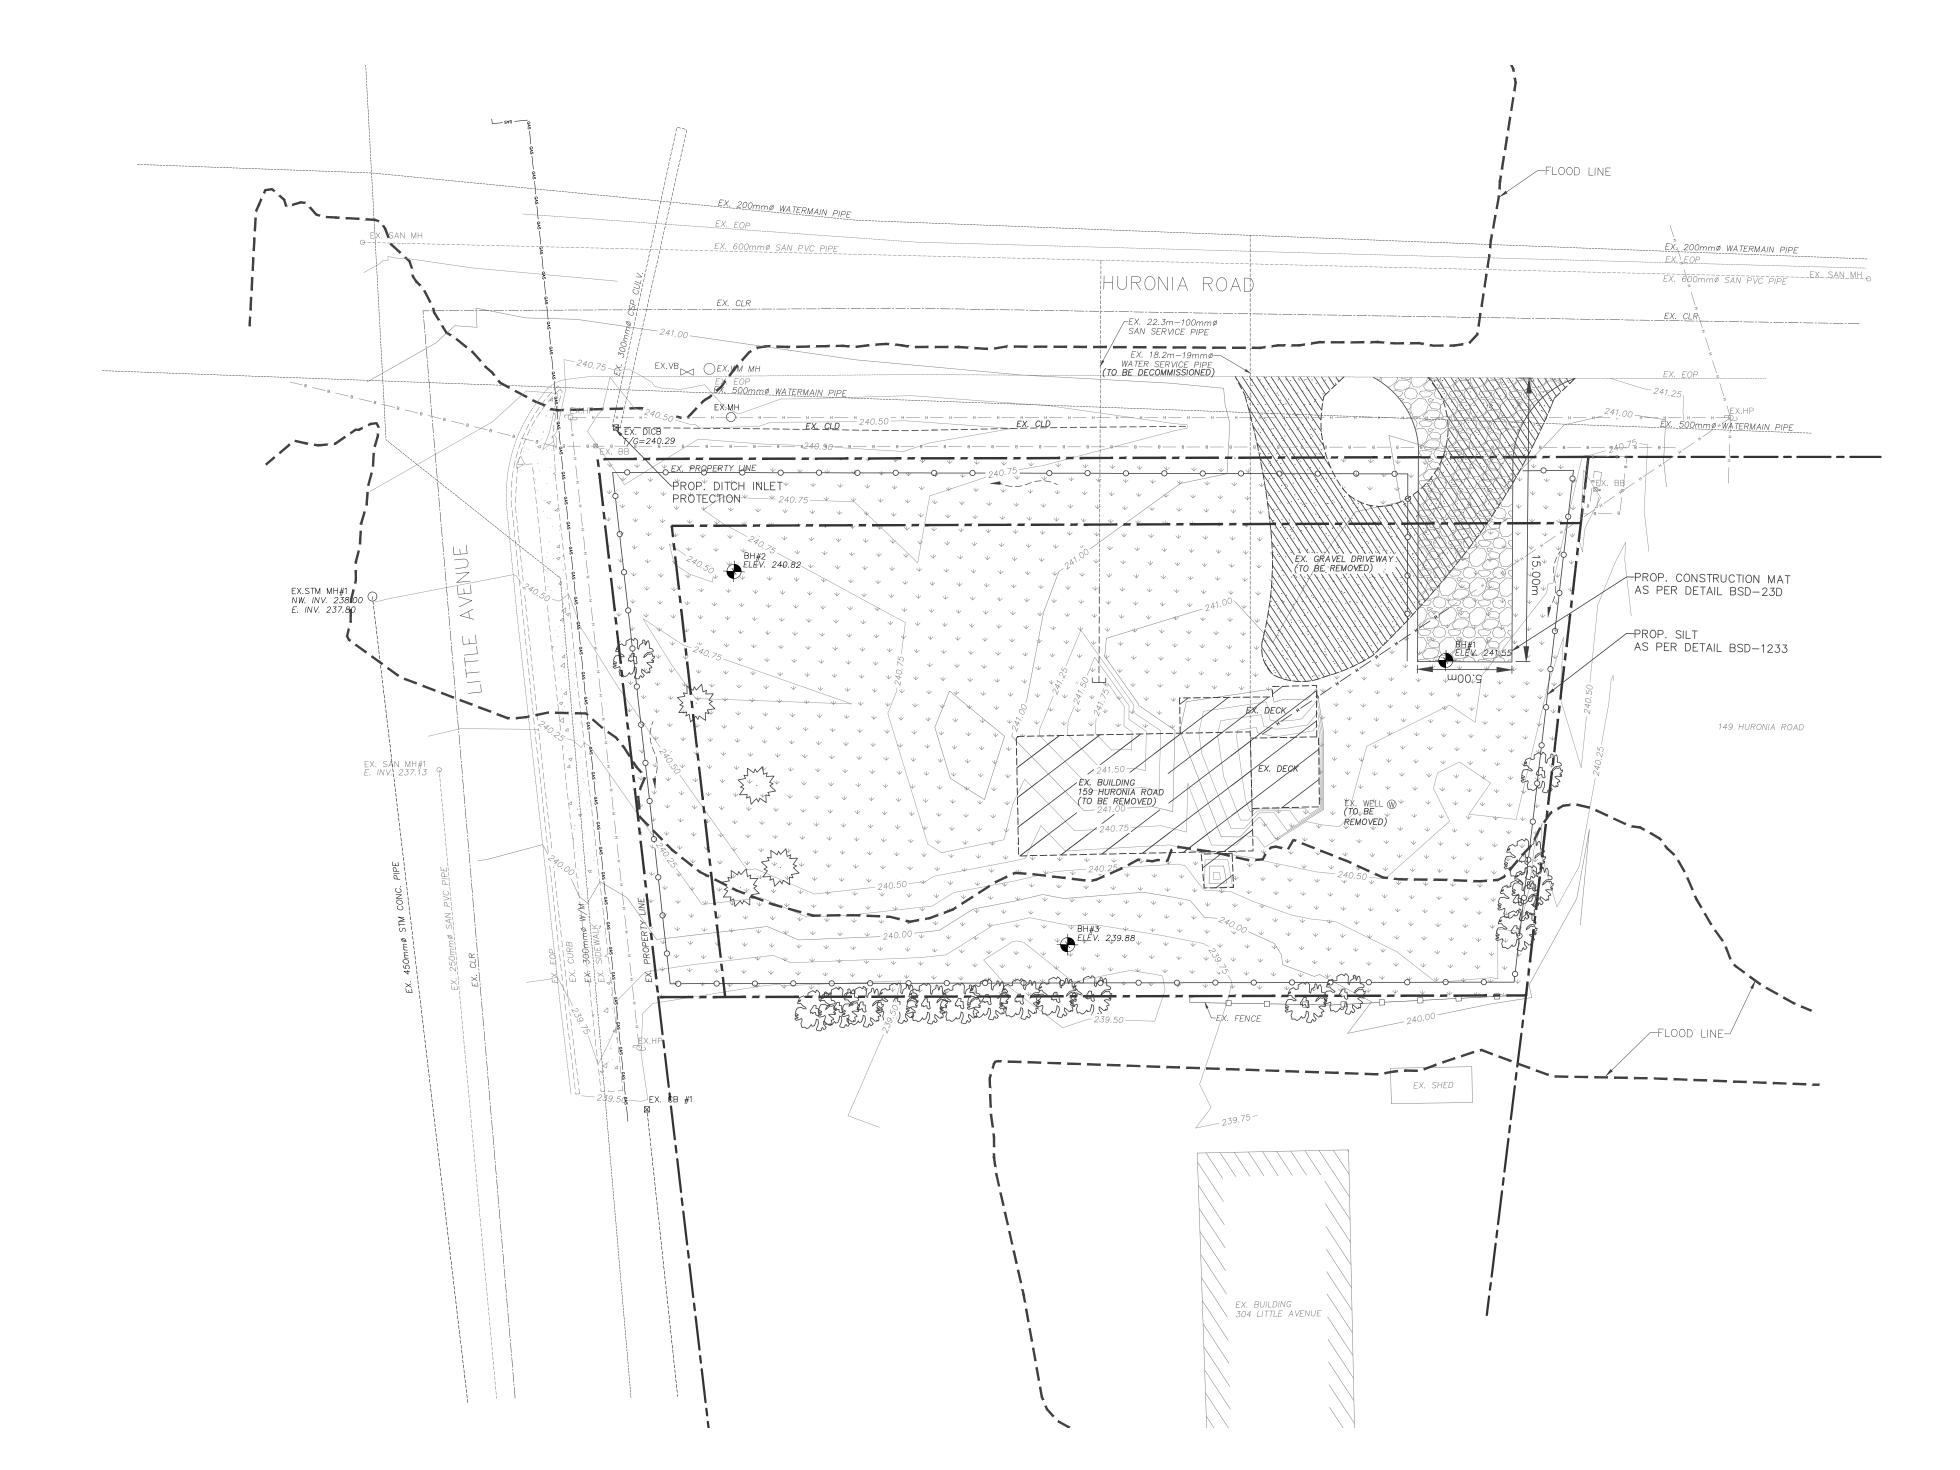

### DRAWINGS

- 1. THE NOTES ON THIS SHEET APPLY TO ALL WORKS UNDER THIS CONTRACT UNLESS OTHERWISE NOTED ON THE SPECIFIC DETAIL DWGS.
- 2. THE STANDARD DRAWINGS OF THE LOCAL MUNICIPALITY, ONTARIO PROVINCIAL STANDARDS AND SPECIFICATIONS (OPSS) AND THE ONTARIO PROVINCIAL STANDARD DRAWINGS (OPSD) CONSTITUTE PART OF THE PLANS OF THIS CONTRACT.
- 3. ORDER OF PRECEDENCE OF STANDARD DRAWINGS IS FIRSTLY THE LOCAL MUNICIPALITY AND SECONDLY ONTARIO PROVINCIAL STANDARD
- 4. THE STANDARD DRAWINGS INCLUDED WITH THESE PLANS ARE PROVIDED FOR CONVENIENCE ONLY AND ARE NOT TO BE CONSTRUED TO BE A COMPLETE SET FOR THE PURPOSE OF THE CONTRACT. IT IS THE CONTRACTOR'S RESPONSIBILITY TO OBTAIN ALL RELEVANT STANDARD DRAWINGS AND SPECIFICATIONS AS REQUIRED FOR THIS CONTRACT.

#### MEASUREMENTS

- 1. ALL DIMENSIONS ARE IN METRES, EXCEPT PIPE DIAMETERS, WHICH ARE IN MILLIMETRES, UNLESS SPECIFIED OTHERWISE.
- 2. ALL DIMENSIONS SHALL BE CHECKED AND VERIFIED IN THE FIELD BY THE CONTRACTOR PRIOR TO ANY CONSTRUCTION, AND ANY DISCREPANCIES SHALL BE REPORTED IMMEDIATELY TO THE ENGINEER.

#### GENERAL

- 1. EXISTING SERVICES AND UTILITIES SHOWN ON THESE CONTRACT DRAWINGS ARE BASED ON THE BEST INFORMATION AVAILABLE AND THEIR LOCATIONS ARE NOT GUARANTEED. THE CONTRACTOR SHALL INTERPRET THIS INFORMATION AS THEY WISH WITH THE UNDERSTANDING THAT THE OWNER DISCLAIMS ALL RESPONSIBILITY FOR ITS ACCURACY AND/OR SUFFICIENCY. THE CONTRACTOR IS REQUIRED TO NOTIFY THE VARIOUS UTILITY COMPANIES 48 HOURS PRIOR TO THE COMMENCEMENT OF ANY WORK.
- 2. NATIVE MATERIAL, SUITABLE FOR BACKFILL, SHALL BE COMPACTED TO 95% STANDARD PROCTOR MAXIMUM DRY DENSITY.
- 3. GRANULAR MATERIAL, USED FOR BACKFILL, SHALL BE PLACED IN LAYERS 150mm IN DEPTH MAXIMUM AND COMPACTED TO 100% STANDARD PROCTOR MAXIMUM DRY DENSITY.
- 4. ALL DISTURBED AREAS ARE TO BE REINSTATED TO THEIR ORIGINAL CONDITION OR BETTER, AS DETERMINED BY THE ENGINEER. ALL GRASS AND VEGETATION COVERED AREAS SHALL BE RESTORED BY PLACING 200mm OF APPROVED TOPSOIL AND NURSERY SOD UNLESS NOTED OTHERWISE.

### PARKING LOT

- 1. NATIVE SUBGRADE TO BE COMPACTED TO MINIMUM 98% STANDARD PROCTOR MAXIMUM DRY DENSITY.
- 2. PAVEMENT STRUCTURE TO BE CONFIRMED BY GEOTECHNICAL ENGINEER PRIOR TO START OF CONSTRUCTION
- 3. THE PARKING LOT PAVEMENT STRUCTURE SHALL CONSIST OF THE FOLLOWING:

### SEWERS

- 1. INTERNAL SANITARY SEWERS AND LATERALS TO BE MINIMUM 150mm DIAMETER PVC DR 28 WITH JOINTS CONFORMING TO CSA STANDARD A257.3.
- 2. SEWERS SHALL BE CONSTRUCTED WITH BEDDING AS PER OPSD 802.010 (GRANULAR 'A' EMBEDMENT MATERIAL), UNLESS APPROVED OTHERWISE BY THE ENGINEER.
- 3. PRECAST MANHOLES SHALL BE 1200mm DIAMETER UNLESS OTHERWISE SPECIFIED, AND SHALL BE IN ACCORDANCE WITH OPSD 701.010. FRAME AND GRATE TO BE "TYPE A" CLOSED COVER AND TO CONFORM TO OPSD 401.010.
- 4. MANHOLE TOPS ARE TO BE SET TO FINAL GRADE.

### WATERMAINS

- 1. THE MINIMUM HORIZONTAL SEPARATION BETWEEN THE WATERMAIN AND THE SANITARY/STORM SEWER IS TO BE 2.5 METERS.
- 2. A MINIMUM OF 0.5m VERTICAL CLEARANCE BETWEEN THE WATERMAIN, SANITARY, STORM AND/OR ALL UTILITIES MUST BE KEPT, WHILE STILL MAINTAINING A MINIMUM DEPTH OF COVER AT ALL TIMES. WHERE WATERMAIN CONFLICTS WITH SEWER PIPE, DEFLECT WATERMAIN HORIZONTALLY OR VERTICALLY TO OBTAIN MINIMUM COVER AND VERTICAL CLEARANCE.
- 3. WATERMAINS SHALL BE PVC DR 18 AND INSTALLED WITH A MINIMUM COVER OF 1.7m (MEASURED FROM FINISHED GRADE TO TOP OF WATERMAIN). IF MINIMUM COVER CAN NOT BE ACHIEVED, INSULATION AS PER DETAIL PROVIDED.
- 4. WATERMAIN SHALL BE CONSTRUCTED WITH BEDDING AS PER OPSD 802.010 (GRANULAR 'A' EMBEDMENT MATERIAL) FOR FLEXIBLE PIPES.
- 5. COPPER WATER SERVICES 25mm DIA. SHALL BE EMBEDDED IN SAND 100mm ABOVE AND BELOW TO CONFORM TO OPSS 1104.010.
- 6. WATERMAIN BEDDING SHALL ADHERE TO THE MUNICIPAL STANDARD AND BE PLACED MIN 150mm BELOW AND 300mm ABOVE THE WATERMAIN.
- 7. CONCRETE THRUST BLOCKS ARE TO BE INSTALLED AT ALL TEES, BENDS, HYDRANTS, ENDS OF MAINS AND CONNECTIONS 100mm AND LARGER AS PER STANDARD DRAWINGS. ALL BENDS TO BE MECHANICALLY RESTRAINED.
- 8. ALL JOINTS MUST BE MECHANICALLY RESTRAINED AND THRUST BLOCKED.
- 9. ANY EXISTING, ON SITE, WATER WELLS MUST BE DECOMMISSIONED.
- 10. WHERE A COPPER SERVICE MUST BE JOINED UNDER THE FLOOR, THE COPPER SHALL BE JOINED BY SILVER SOLDER CONNECTION ONLY.
- 11. ALL SERVICE PIPE MATERIAL MUST BE DUCTILE IRON AND MECHANICALLY RESTRAINED FROM THE RESTRAINED FROM THE RESTRAINING FLANGE TO A MINIMUM OF 3 METERS OUTSIDE THE FOUNDATION. ALL DUCTILE SHALL BE POLY WRAPPED FOR ADDED PROTECTION.
- 12. OPERATION OF FIRE HYDRANTS AND VALVES ON POTABLE WATER BY OTHER THAN MUNICIPAL CITY DEPARTMENT IS PROHIBITED.
- 13. THE CITY WILL SWAB, CHLORINATE AND FLUSH ALL NEW SERVICES. THE CONTRACTOR SHALL PERFORM PRESSURE TEST WITH WATER FIELD COORDINATOR WITNESSING.
- 14. EXTERNAL CONTRACTOR TO COORDINATE WITH INTERNAL CONTRACTOR ON ALL INSTALLATION, SWABBING, CHLORINATING AND TESTING WITNESSED BY WATER FIELD SERVICES COORDINATOR.
- 15. MECHANICAL RESTRAINTS WILL BE REQUIRED ON ALL HYDRANTS. A MINIMUM OF TWO PIPE LENGTHS OF EITHER SIDE OF THE HYDRANT TEE CONNECTION. HYDRANTS TO BE PAINTED RED.
- 16. TRACING WIRE (#12 TWU STRANDED COPPER) TO BE INSTALLED ON THE TOTAL LENGTH OF ALL PVC WATERMAINS AND BROUGHT UP AT EACH HYDRANT AND CONNECTED TO FLANGE BOLT.
- 17. SERVICE CONNECTIONS SHALL BE PLACED AT A MINIMUM SEPARATION OF 1.0m AND A MINIMUM OF 0.6m FROM JOINTS.
- 18. CONTRACTOR TO PROVIDE PLAN FOR REMOVING CHLORINATED WATER FROM
- 19. A CHLORINATION TAIL SHALL BE INSTALLED JUST BEHIND TAPPING VALVE TO FACILITATE CHLORINATING SERVICE, TO BE REMOVED AFTER

### GENERAL NOTES - WATERMAIN

1. CONTRACTORS SHALL INFORM THE CITY OF BARRIE WATER OPERATIONS DEPARTMENT A MINIMUM OF 48 HOURS IN ADVANCE OF THEIR INTENTIONS TO PERFORM WORK ON WATER INFRASTRUCTURE. 2. OPERATION OF HYDRANTS AND VALVES ON THE POTABLE WATER SYSTEM BY OTHER THAN QUALIFIED WATER OPERATIONS STAFF IS PROHIBITED BY CURRENT BY-LAW. CITY SERVICE FEES ARE PER THE CURRENT FEES BY-LAW. THE CITY'S WATER OPERATIONS STAFF WILL SWAB, PRESSURE TEST, CHLORINATE AND FLUSH ALL NEW WATERMAINS.

5. COPPER WATER MAINS AND SERVICES 25mm TO 50mm IN DIAMETER SHALL BE EMBEDDED IN SAND 100mm ABOVE AND BELOW TO CONFORM TO OPSS.MUNI 1004 05.07. 6. RESTRAINING WILL BE REQUIRED ON ALL HYDRANTS. THRUST BLOCKS, AS PER OPSD 1103.010 AND 1103.020. RESTRAINING DEVICES MAY BE REQUIRED IN ADDITION TO STANDARD CONCRETE THRUST BLOCKING WHERE SOIL CONDITIONS WARRANT AT THE CITY'S DISCRETION

7. NEW WATERMAINS TO BE PVC DR18 CL150 MINIMUM; DUCTILE IRON CL52 AS PER THE APPROVED MANUFACTURERS PRODUCTS FOR LINEAR WATER SYSTEMS LIST. 8. TRACING WIRE SHALL BE #12 AWG HIGH STRENGTH COPPER CLAD (HS-CSS) AND SHALL BE INSTALLED ON THE TOTAL LENGTH OF ALL WATERMAIN AND BROUGHT UP AT EACH HYDRANT AND CONNECTED TO FLANGE BOLT. ALL SPLICES TO UTILIZE CONNECTORS AS PER THE APPROVED WANDFACTURERS PRODUCTS FOR LINEAR WATER SYSTEMS LIST. 9. ALL WATER SERVICES SHALL BE MINIMUM 25mm TYPE 'K' COPPER OR 25mm CROSS-LINKED POLYETHYLENE UNLESS OTHERWISE APPROVED B'
THE DIRECTOR OF WATER OPERATIONS. WATER SERVICE SADDLES SHALL BE USED WHEN TAPPING INTO PVC WATERMAIN. 10. SERVICE TAPPINGS SHALL BE PLACED AT A MINIMUM SEPARATION OF 1.0m AND A MINIMUM OF 0.6m FROM JOINTS, (ENDS OF PIPE)

11. RISER PIPES ARE TO BE INSTALLED AS PER BSD-510, AND REMOVED AS DIRECTED. SWABBING SCHEDULE TO BE SUPPLIED BY A WATER OPERATIONS FIELD REPRESENTATIVE. ALL RISERS ARE TO BE RESTRAINED OR THRUST BLOCKED.

A. SANITARY LATERAL CONNECTION TO BE LOCATED AT THE CENTRELINE OF THE LOT AND CAPPED.

B. LOCATION OF LATERAL TO BE MARKED 2.0m PAST PROPERTY LINE WITH A 50 x 100mm WOOD MARKER, PAINTED GREEN, EXTENDING FROM SERVICE INVERT TO 300mm ABOVE GROUND LEVEL.

C. PIPE TO BE MINIMUM 100 mm DIA. PVC SDR28, RUBBER GASKET TYPE JOINTS AND SHALL CONFORM TO C.S.A. (B-182.2.3.4) (COLOURED) FOR A RESIDENTIAL HOUSE AND 150mm MINIMUM DIA. PVC SDR28 FOR INDUSTRIAL/COMMERCIAL DEVELOPMENT.

D. MINIMUM DEPTH OF LATERAL AT PROPERTY LINE SHALL BE 2.4m MEASURED FROM THE SEWER OBVERT TO FINISHED GROUND SURFACE ELEVATION UNLESS NOTED OTHERWISE. ALL CONNECTIONS TO NEW SANITARY MAINS SHALL BE PRE—MANUFACTURED, FABRICATED TEES. CONNECTIONS TO EXISTING SANITARY SEWER SHALL BE MADE WITH APPROVED FACTORY MADE TEES OR INSERTA—TEES IN STRICT ACCORDANCE TO MANUFACTURES GUIDELINES.

F. MINIMUM PIPE SLOPE TO BE 2.0%, MAXIMUM 8.0% (SEE OPSD-1006.010, 1006.020).

GENERAL NOTES - WATERMAIN

12. ALL NEW CURB STOPS AND BOXES TO BE LOCATED AT PROPERTY. LINE AND OUT OF DRIVEWAYS AND SIDEWALKS.

GENERAL NOTES - SANITARY SEWER

SANITARY SERVICE LATERALS

CITY OF BARRIE STANDARD

GENERAL NOTES

**SANITARY SEWERS** 

ELBOW AS REQUIRED

NEW OR EXISTING CULVERT, —— STORM SEWER, OR DITCH

I. LOWERED SECTION OF WATERMAIN TO BE SAME MATERIAL AND CLASS AS EXISTING. 2. ALL JOINTS TO BE MECHANICALLY RESTRAINED, INCLUDING JOINTS ON EXISTING WATERMAIN. 9. ALL DIMENSIONS IN MILLIMETERS UNLESS OF THERWISE NOTED.

BARRIE WATERMAIN CROSSING NEW OR EXIST.

LOWERING DETAILOF NEW OR EXIST.

CULVERT, STORM SEWER OR DITCH

**SOAKAWAY PIT** 

**USING ROOF LEADERS** 

APPROVED

SECTION A - A

REMOVABLE — SECTION

BARRIE

\_\_\_\_ A

THINTH

SCALE: N.T.S. Linublos BSD-500



R.G.N. DATE: 92.05

BSD-N4

SIRECTOR OF ENGINEERING

**APPROVED** 

riginal Signe

TAINLESS STEEL TIE RODS, LENGTHS AS REQ'D


BSD-519

GEOTEXTILE, OPSS 1860 CLASS II

SCALE: N.T.S.

BSD-1406

- MIN 300mm OF 50mm CLEAR STONE, WASHED

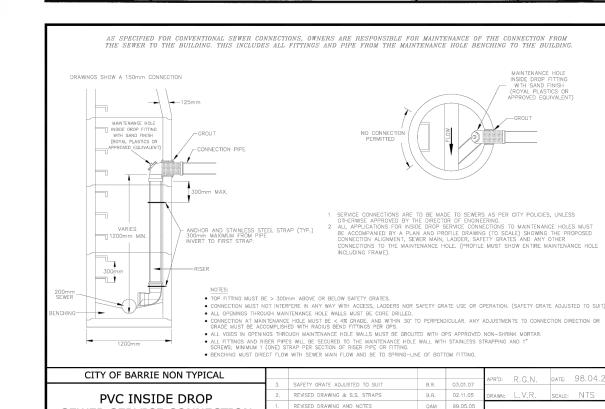

WATERMAIN CROSSING DETAIL

SECTION A-A

BARRIE

STANDARD DETAIL


PIPE LINE SPACERS REQUIRED. ICATION MATERIAL LIST FOR APPROVED LIST OF SPACERS


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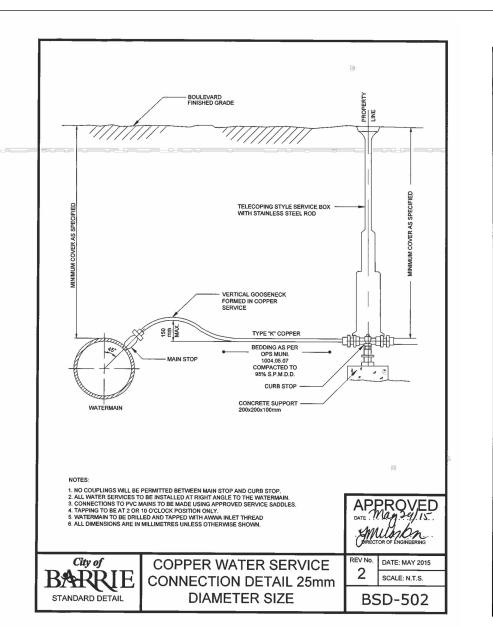
ALL DIMENSIONS ARE IN MILLIMETRES OR METRES UNLESS OTHERWISE


SHOP DRAWING REQUIRED SEALED BY A PROFESSIONAL


BSD-522




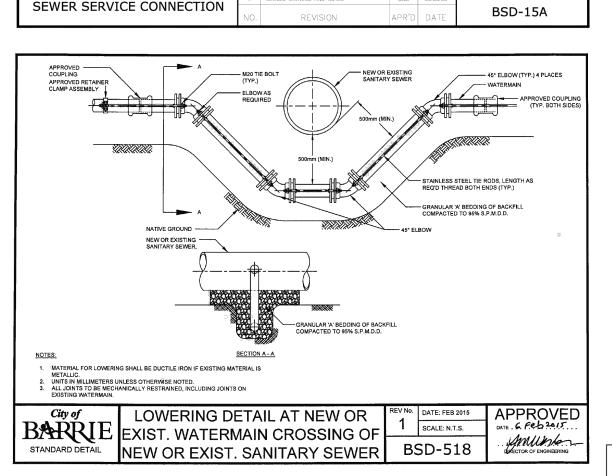

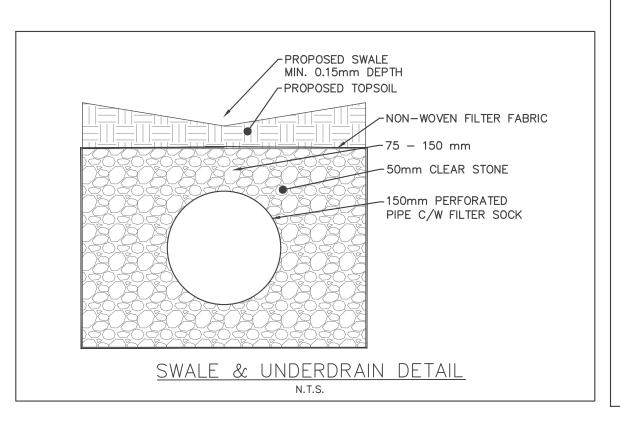

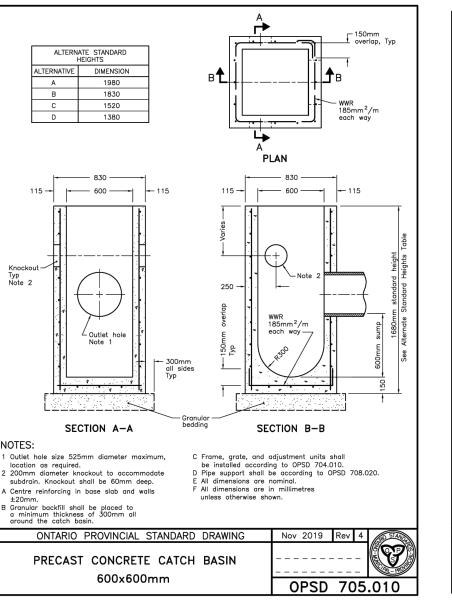

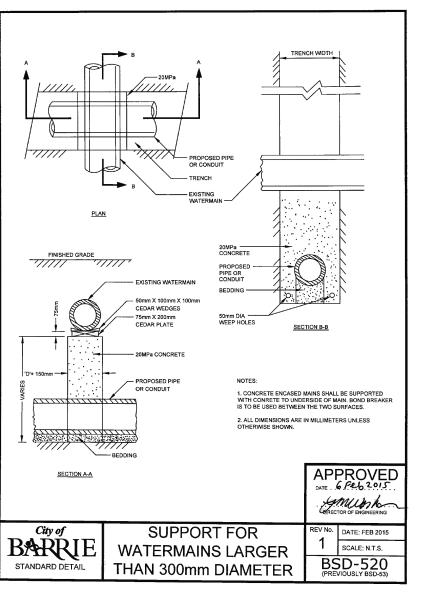

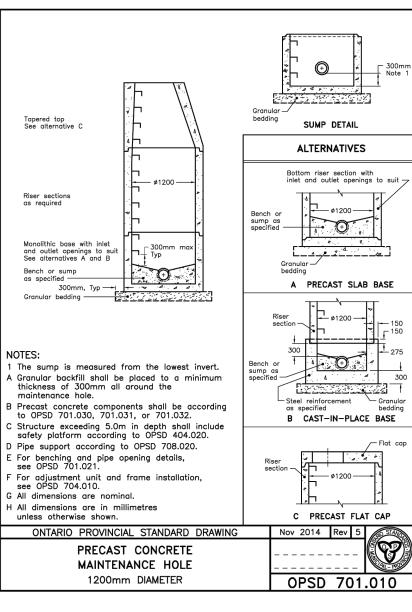



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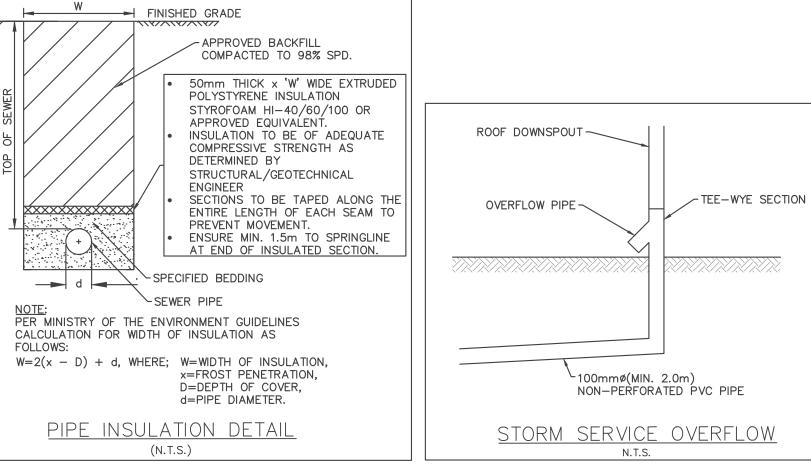
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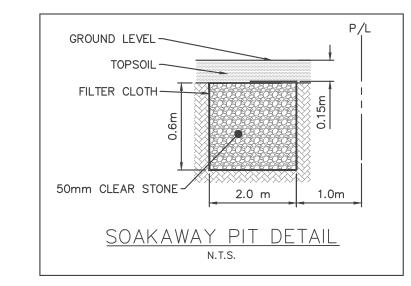
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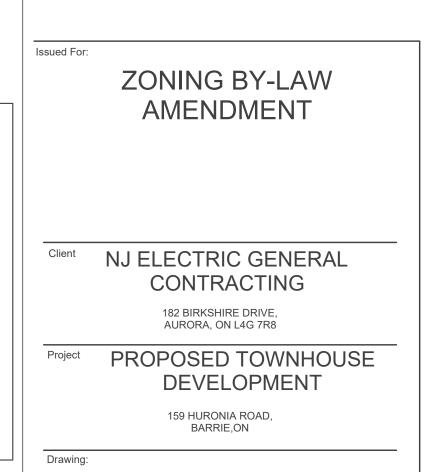
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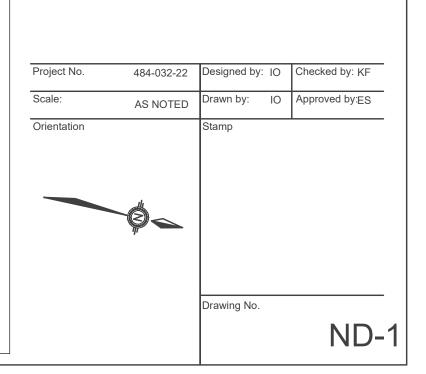
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YY/MM/DD Issuance Description ZONING BY-LAW AMENDMENT











NOTES & DETAILS

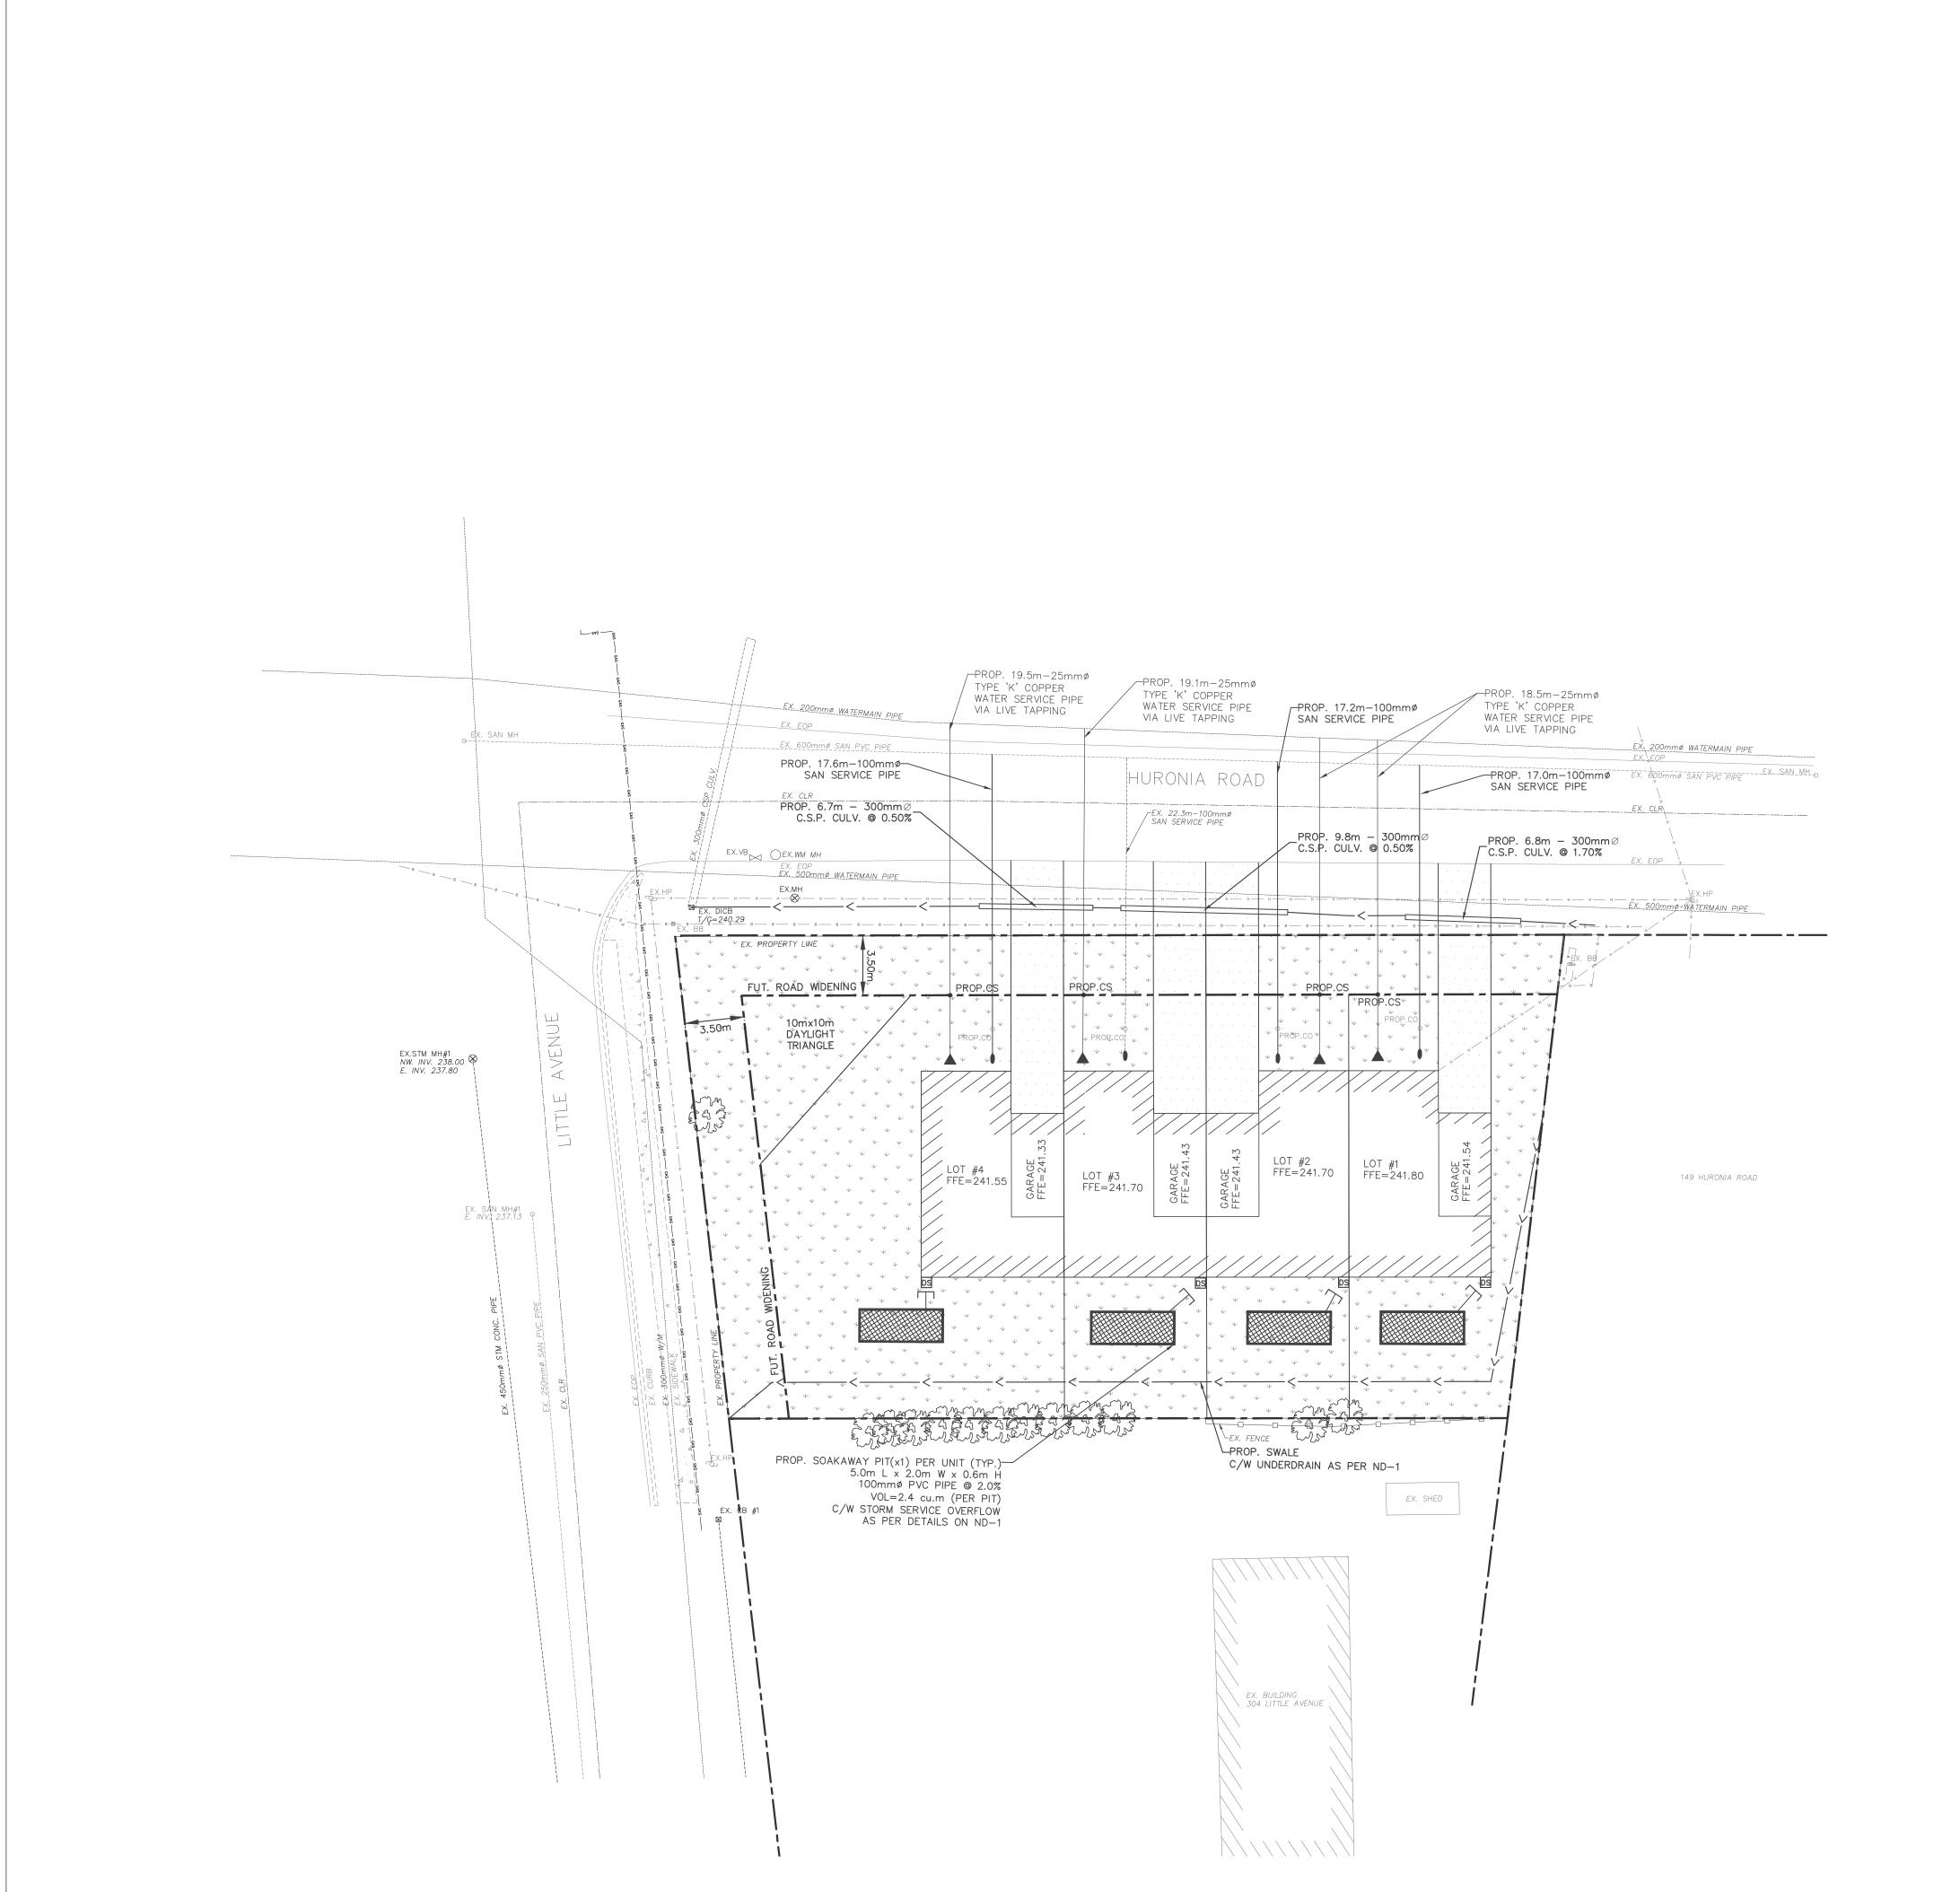

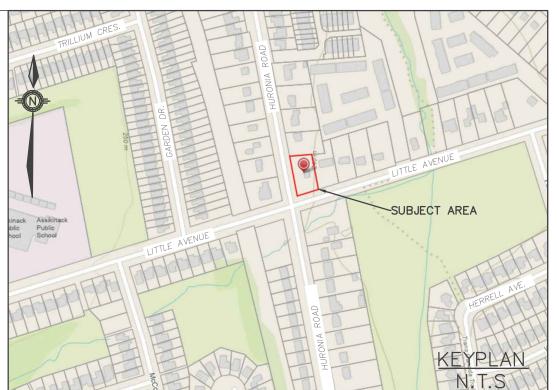

———————— ACOUSTIC FENCE ---x---x--- CHAIN LINK FENCE ——o—o— SILT FENCE ——— GAS ——— GAS LINE ——— H ——— HYDRO LINE ——— B ——— BELL LINE EXISTING SANITARY MAINTENANCE HOLE PROPOSED SANITARY MAINTENANCE HOLE EXISTING CATCH BASIN PROPOSED CATCH BASIN EXISTING STORM MAINTENANCE HOLE STM#
O PROPOSED STORM MAINTENANCE HOLE □ SERVICE CAP DOWN SPOUTS FIRE DEPT CONNECTION #YD&V# EXISTING FIRE HYDRANT HYD&V# → PROPOSED FIRE HYDRANT VB# ⋈ EXISTING VALVE BOX VB# ▶ PROPOSED VALVE BOX PROPOSED SIGN EXISTING LIGHT POLE MANDOOR OVERHEAD DOOR SANITARY SERVICE ▲ WATER SERVICE LANDSCAPE AREA ASPHALT AREA CONCRETE AREA

# Gerrits

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0 5 10 20 30 40 50mm

0" 1/4" 1/2" 1" 1 1/2" 2"

D. Issuance Description YY/MM/DD

. ZONING BY-LAW AMENDMENT 23/03/31

Issued For:

# ZONING BY-LAW AMENDMENT

NJ ELECTRIC GENERAL CONTRACTING

182 BIRKSHIRE DRIVE, AURORA, ON L4G 7R8

Project PROPOSED TOWNHOUSE DEVELOPMENT

159 HURONIA ROAD, BARRIE,ON

g:

SITE SERVICING PLAN

Project No. 484-032-22 Designed by: IO Checked by: KF


Scale: 1:200 Drawn by: IO Approved by:ES


Orientation Stamp



Drawing No.

SS-1

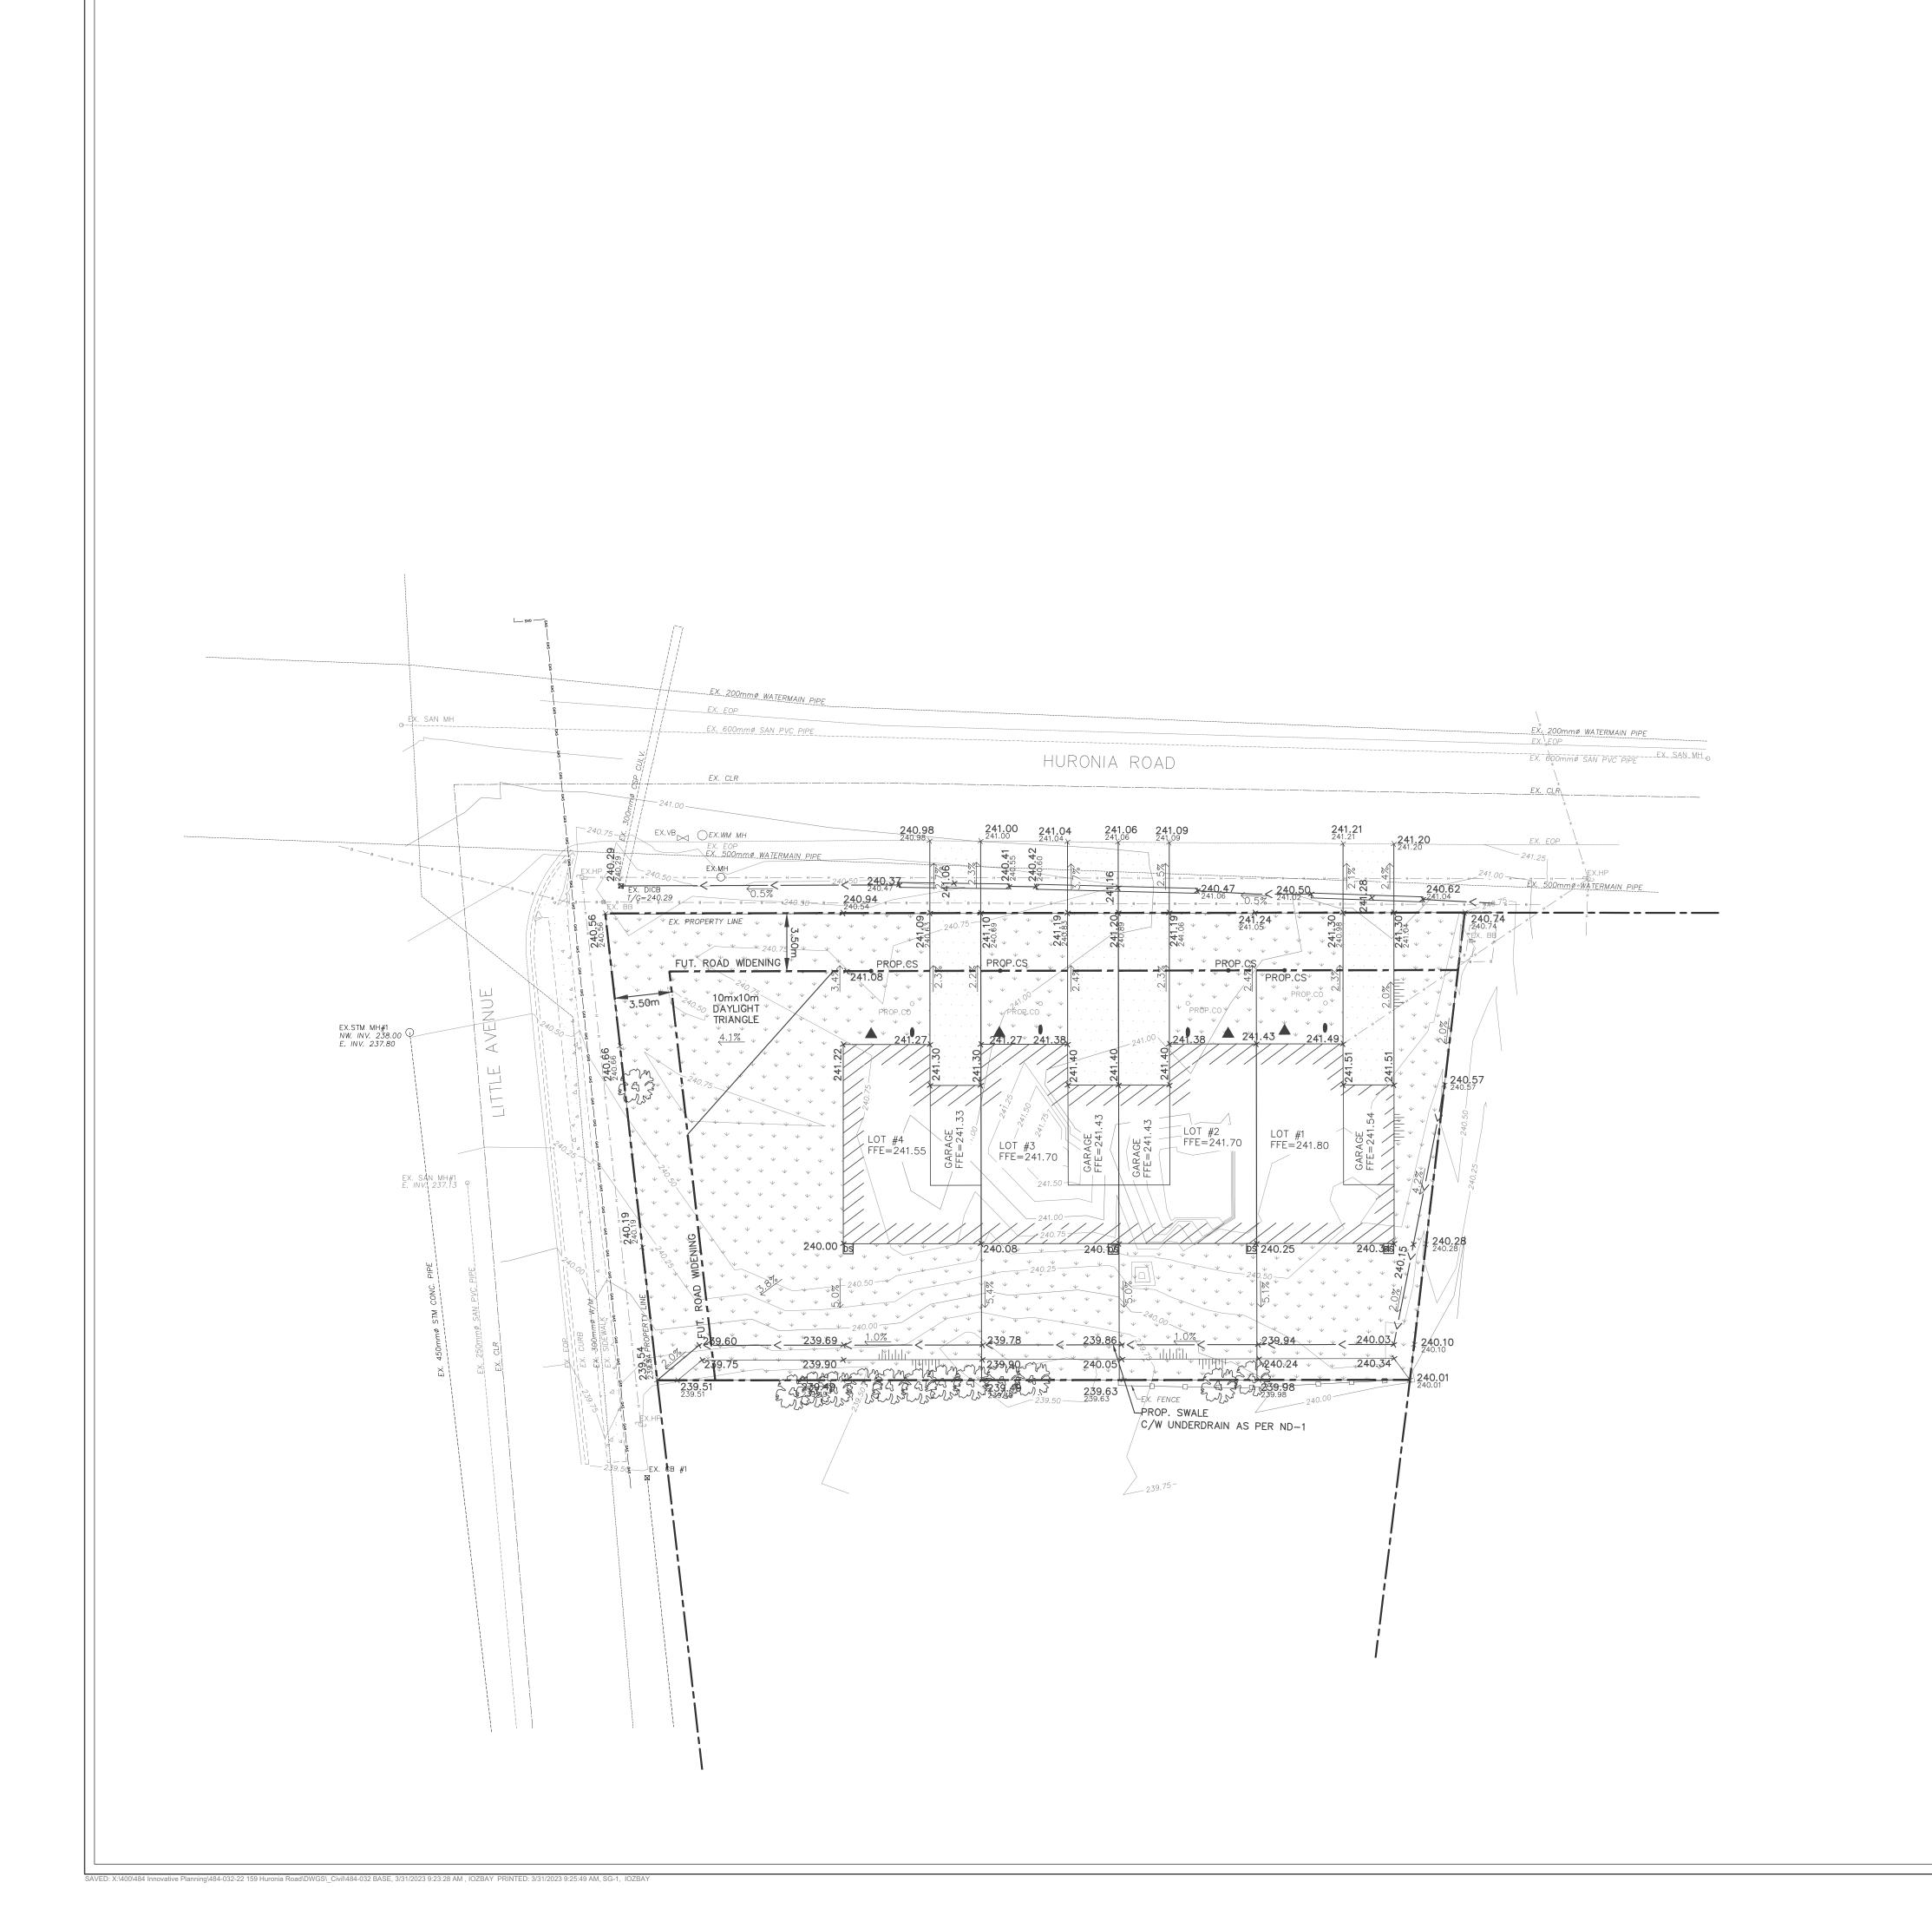

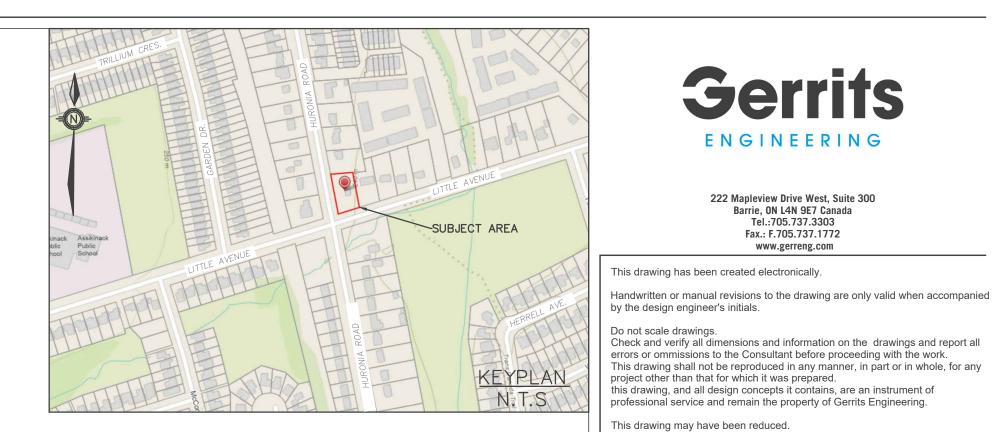

—————— ACOUSTIC FENCE ——o—o— SILT FENCE ——— GAS ——— GAS LINE ——— H ——— HYDRO LINE ——— в ——— BELL LINE EXISTING SANITARY MAINTENANCE HOLE PROPOSED SANITARY MAINTENANCE HOLE " 

EXISTING CATCH BASIN CB# PROPOSED CATCH BASIN EXISTING STORM MAINTENANCE HOLE STM#
O PROPOSED STORM MAINTENANCE HOLE ☐ SERVICE CAP DOWN SPOUTS > FIRE DEPT CONNECTION HYD&V# \* EXISTING FIRE HYDRANT HYD&V# → PROPOSED FIRE HYDRANT EXISTING VALVE BOX VB# ► PROPOSED VALVE BOX PROPOSED SIGN \* EXISTING LIGHT POLE MANDOOR OVERHEAD DOOR

×220.75 PROPOSED ELEVATION EXISTING ELEVATION

LANDSCAPE AREA

ASPHALT AREA

CONCRETE AREA

2.0% PROPOSED GRADE

3:1 MAX SLOPE

) ( HIGH POINT

**▼**\_\_\_\_ SWALE

Issued For:

# **ZONING BY-LAW AMENDMENT**

ENGINEERING

222 Mapleview Drive West, Suite 300 Barrie, ON L4N 9E7 Canada Tel.:705.737.3303 Fax.: F.705.737.1772 www.gerreng.com

YY/MM/DD

0 5 10 20 30 40 50mm 0" 1/4" 1/2" 1" 1 1/2" 2"

Issuance Description

ZONING BY-LAW AMENDMENT

Client NJ ELECTRIC GENERAL CONTRACTING

182 BIRKSHIRE DRIVE, AURORA, ON L4G 7R8

Project PROPOSED TOWNHOUSE DEVELOPMENT

159 HURONIA ROAD, BARRIE,ON

SITE GRADING PLAN


484-032-22 Designed by: IO Checked by: KF

Scale:	1:200	Drawn by:	Ю	Approved by:ES
Orientation		Stamp		

Drawing No.

SG-1



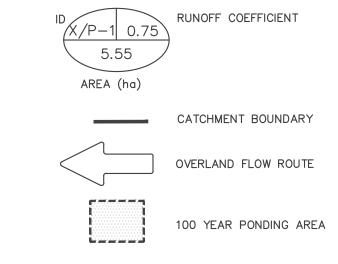

FLOOD LINE

# Gerrits

222 Mapleview Drive West, Suite 300 Barrie, ON L4N 9E7 Canada Tel.:705.737.3303 Fax.: F.705.737.1772 www.gerreng.com

This drawing has been created electronically.

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Do not scale drawings.
Check and verify all dimensions and information on the drawings and report all errors or ommissions to the Consultant before proceeding with the work.
This drawing shall not be reproduced in any manner, in part or in whole, for any project other than that for which it was prepared.
this drawing, and all design concepts it contains, are an instrument of professional service and remain the property of Gerrits Engineering.

This	s dra	awing r	nay ha	ve been	reduced	l.	
0	5	10	20	30	40	50mm	
$\vdash$	4						
0"	1/4	" 1/2"		1"	1 1/2"	2"	
0	1/4	1/2"		1"	1 1/2"	2"	

No.	Issuance Description	YY/MM/DD
1.	ZONING BY-LAW AMENDMENT	23/03/31
2.		

### Issued For

# ZONING BY-LAW AMENDMENT

Client NJ ELECTRIC GENERAL CONTRACTING

182 BIRKSHIRE DRIVE, AURORA, ON L4G 7R8

Project PROPOSED TOWNHOUSE DEVELOPMENT

159 HURONIA ROAD, BARRIE,ON

PRE-DEVELOPMENT STORMWATER MANAGEMENT PLAN


Project No. 484-032-22 Designed by: IO Checked by: KF


Scale: 1:200 Drawn by: IO Approved by:ES




Drawing No.

STM-1

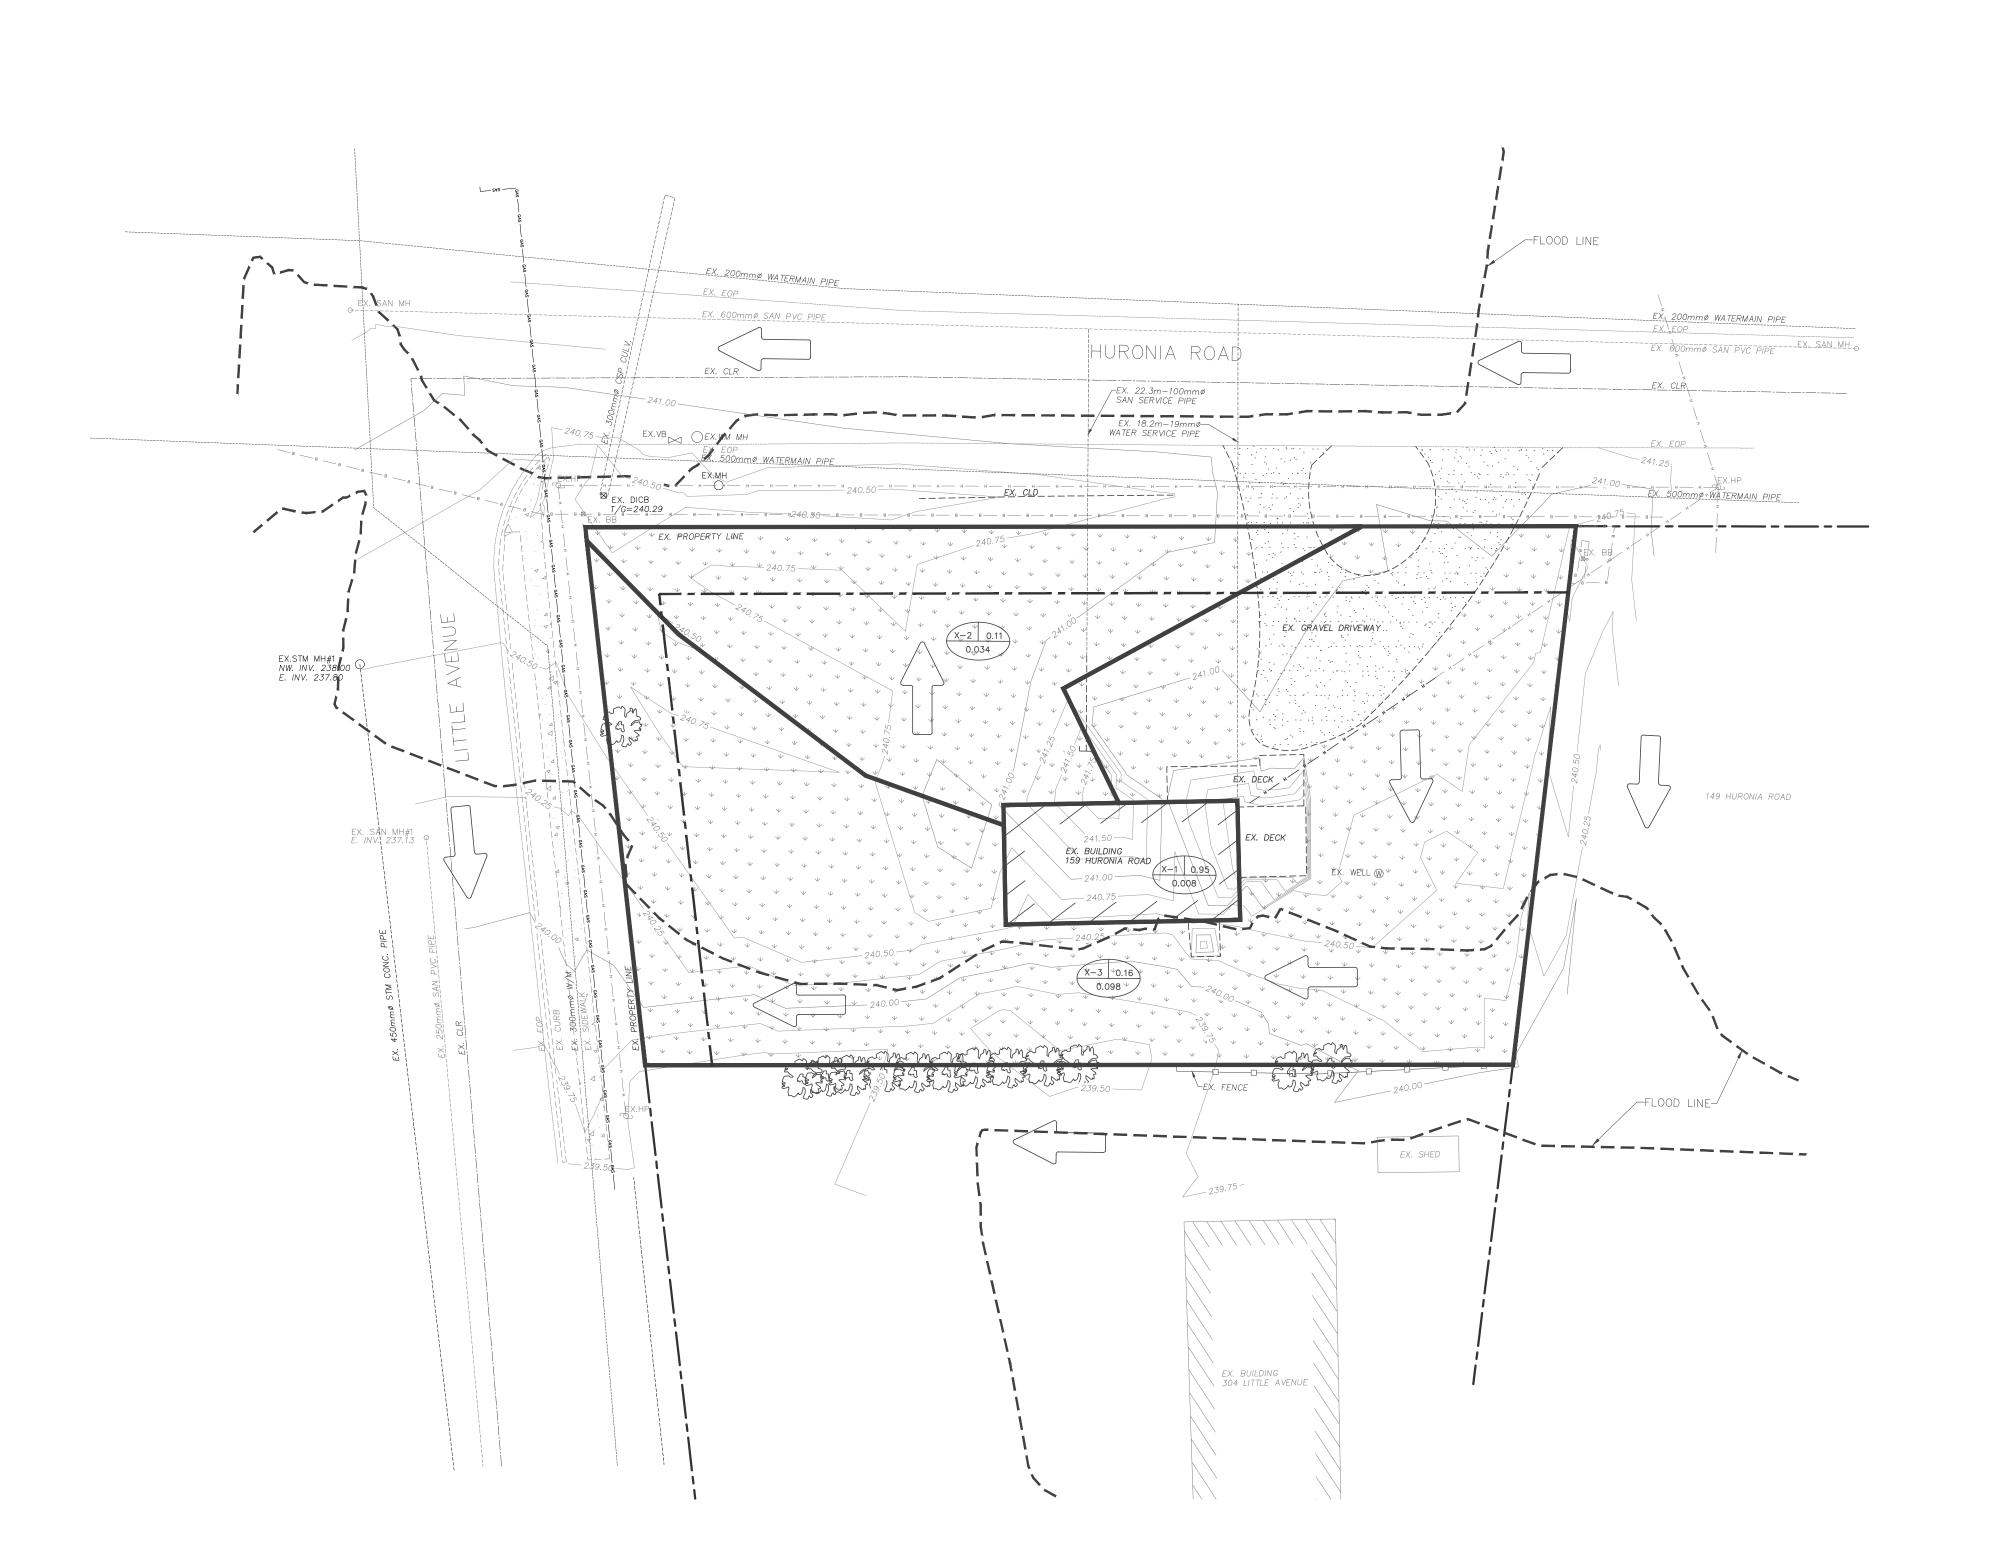

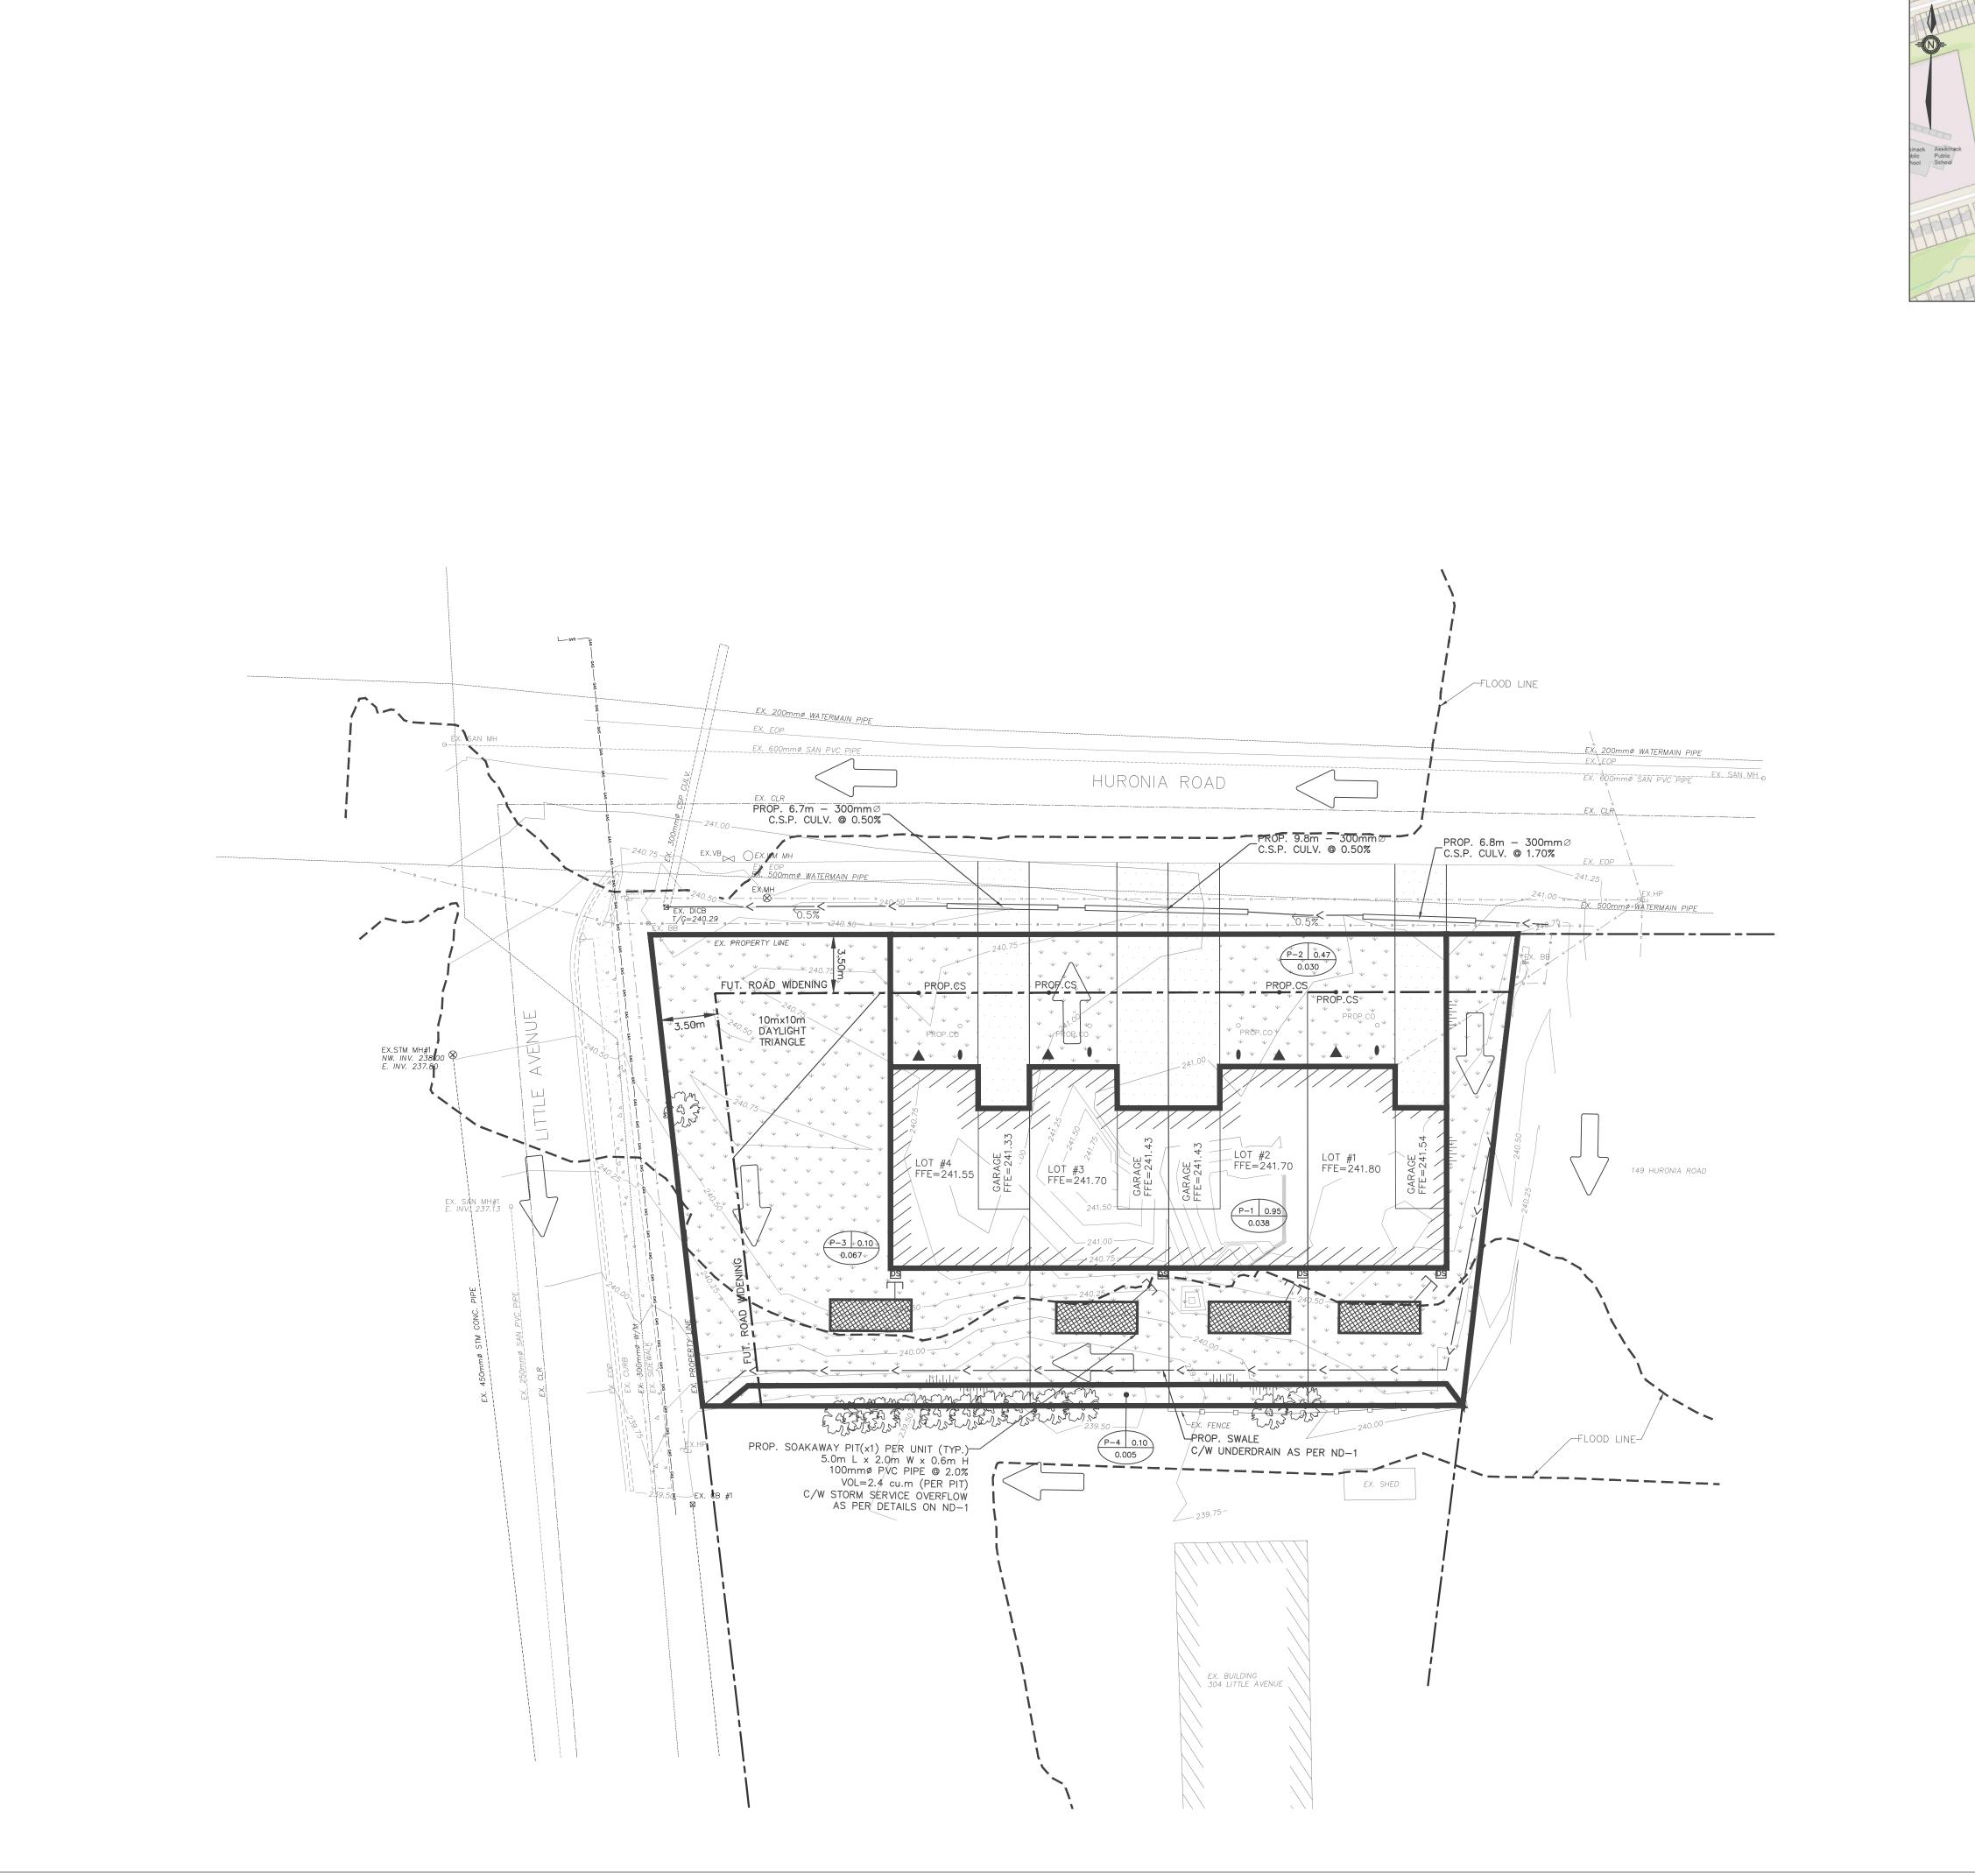

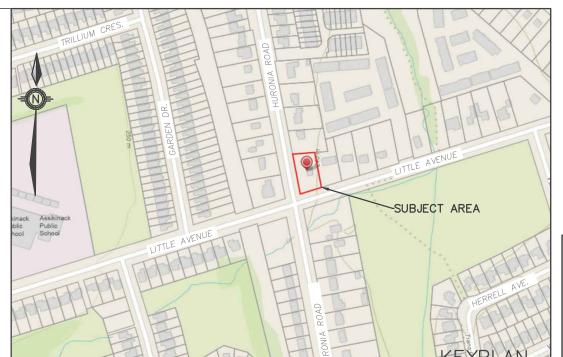

RUNOFF COEFFICIENT (X/P-1) 0.75

CATCHMENT BOUNDARY



FLOOD LINE

# ENGINEERING

222 Mapleview Drive West, Suite 300 Barrie, ON L4N 9E7 Canada Tel.:705.737.3303 Fax.: F.705.737.1772 www.gerreng.com

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This drawing may have been reduced. 0 5 10 20 30 40 50mm 0" 1/4" 1/2" 1" 1 1/2" 2"

YY/MM/DD Issuance Description ZONING BY-LAW AMENDMENT

## **ZONING BY-LAW AMENDMENT**

Client NJ ELECTRIC GENERAL CONTRACTING

182 BIRKSHIRE DRIVE, AURORA, ON L4G 7R8

Project PROPOSED TOWNHOUSE DEVELOPMENT

159 HURONIA ROAD, BARRIE,ON

POST-DEVELOPMENT STORMWATER MANAGEMENT PLAN

484-032-22 Designed by: IO Checked by: KF 1:200 Drawn by: IO Approved by:ES

Drawing No.

STM-2