

Proposed

Proposed

Coniferous Tree

Proposed Curb Typ.

Proposed Seatwall

Proposed Bike

Deciduous Tree



Key Map

Municipality: The City of
BARRIE

**MARTON SMITH LANDSCAPE ARCHITECTS** 

170 The Donway W Suite 206. Toronto, Ontario, Canada. M3C 2G3

tel. 416.492.9966 | email. info@msla.ca

I └ JULIUS HORVATH

OFFICE:3100 Steeles Ave. West, Suite 406

O.A.A. LEED AP

■ www.jhorvatharchitect.com

C: 289-380-0407 julius@jhorvatharchitect.com

Architact.

Client/Owner:

## **Proposed Plant Material List**

Prop. Sodded

Prop. Concrete

Paving Typ.

Prop. Unit

Proposed

Detail

Paving Type 1

Planting Area

Reference Key

Plant Material

Reference Key

Area Typ.

KEY	QNTY BOTANICAL NAME	COMMON NAME	HT/CAL	SPREAD	ROOT	DROUGHT TOLERANT	NATIVE	REMARKS
DECIDUOL	JS TREES							
AAD	Amelancier arborea	Downy Serviceberry (Tree Form)	50 mm		B.&B.	High	Yes	Tree Form
ASC	Acer saccharum	Sugar Maple	70 mm		B.&B.	High	Yes	Full Form
ARU	Acer rubrum	Native Red Maple	70 mm		B.&B.	High	Yes	Full Form
BPA	Betula papyrifera 'Multi-Stem'	Paper Birch	70 mm		B.&B.	High	Yes	2-3 Leader Multistem
CEH	Celtis occidentalis	Hackberry	70 mm		B.&B.	High	Yes	Full Form
GSK	Gleditsia triacanthos 'Skyline'	Skyline Honey-Locust	70 mm		B.&B.	High	Yes	Full Form
LTP	Liriodendron tulipifera	Tulip Tree	70 mm	cream	B.&B.	High	Yes	Full Form
QRB	Quercus rubra	Red Oak	70 mm		B.&B.	High	Yes	Full Form
CONIFERO	OUS TREES							
ABA	Abies balsamea	Balsam Fir	200 cm		B.&B.	High	Yes	Full Form
AFS	Abies fraseri	Fraser Fir	200 cm		B.&B.	High	Yes	Full Form
PGL	Picea glauca	White Spruce	200 cm		B.&B.	High	Yes	Full Form
	·							
PSB	Pinus strobus	White Pine	200 cm		B.&B.	High	Yes	Full Form
TCA	Tsuga canadensis	Canadian Hemlock	200 cm		B.&B.	High	Yes	Full Form
DECIDUOL	JS SHRUBS	·	•	•				
EFS	Euonymus fortunei 'Sarcoxie'	Sarcoxie Euonymus			C.G.	Yes	No	Full Form
HPB	Hydrangea paniculata 'Bombshell'	Dwarf Bombshell Hydrangea	60 cm		5 gal.	No	No	Full Form
HP0	Hydrangea quercifolia 'Oak leaf'	Oak leaf Hydrangea	60 cm		C.G.	No	No	Full Form
POD	Physocarpus opulifolius 'Diablo'	Diablo Purpleleaf Ninebark	80 cm		C.G.	Yes	Yes	Full Form
SJL	Spirea japonica 'Little Princess'	Dwarf Red Spirea	60 cm		C.G.	Yes	Yes	Full Form
SMP	Syringa meyeri 'Palibin'	Purple Dwarf Korean Lilac	60 cm		C.G.	Yes	No	Full Form
CONIFERO	DUS SHRUBS							
TCF	Taxus cuspidata 'Fairview'	Fairview Yew		65 cm	C.G.	High	Yes	Full Form
JCG	Juniper chinensis 'Gold Coast'	Gold Coast Juniper		70 cm	C.G.	High	Yes	Full Form
GRASSES								
CAC	Calamagrostis acutiflora 'Karl Foerster'	Karl Foerster Feather Reed Grass			5 Gal.	Yes	No	Full Form
PAF	Pennisetum alopecuroides	Fountain Grass			2 Gal.	Yes	No	Full Form
PERENNIA	LS							
GEW	Geranium sanguiineum 'Alba'	White Hardy Geranium			2 Gal.	No	No	White Flowers
PLS	Perovskia atriplicifolia 'Little Spire'	Little Spire Russian Sage			2 Gal.	Yes	No	Full Form
SAM	Salvia x sylvestris 'May Night'	May Night Salvia			2 Gal.	Yes	No	Full Form

## **Tree Planting Info**

Site Area: 7600 sq.m.

No. of Deciduous Trees required: 38 (7600 sq.m / 200 = 38)

No. of Coniferous Trees required: 19

North		Date
No	Revision	Date
01	Issued for Review	07/26/21
02	Revised per Comments	09/22/21
03	Revised per Comments	09/23/21
04	Issued for Review	11/01/21
05	Issued for Review	11/09/21
06	Issued for Submission	12/02/21
07	Issued for SPA	02/17/22





Proposed Landscape and Site Upgrades 101 - 111 Edgehill Drive Barrie, Ontario

**1:250** Date: **Jul 2021** S.P Checked By: L.M. Drawn By:

Drawing Title:

Landscape Plan

L1-01

### LANDSCAPE SPECIFICATIONS

CONTRACTOR MUST CONTACT ALL UTILITY COMPANIES FOR STAKE OUTS PRIOR TO ANY EXCAVATION OR PLANTING.

ROUGH GRADE AND FILL AREAS TO ESTABLISH SUBGRADE AS REQUIRED. PROVIDE DRAINAGE PATTERN AS INDICATED ON DRAWINGS. ROUND SMOOTHLY ALL TOPS AND TOES OF SLOPES. COMPACT ALL AREAS TO 95% STANDARD PROCTOR DENSITY UNLESS SPECIFIED OTHERWISE, EXISTING TREES TO REMAIN ON SITE ARE TO BE PROTECTED AS DETAILED.

FINE GRADE ALL AREAS TO FINISHED GRADES AS SHOWN ON LAYOUT OR GRADING PLAN OR ARCHITECT'S SITE PLAN. PROVIDE UNIFORM SLOPES AWAY FROM THE BUILDING, UNLESS SPECIFIED OTHERWISE. SLOPES MAY NOT EXCEED 33 1/3% (3:1). SPREADING OF TOPSOIL

SCARIFY THE SUBSOIL PRIOR TO THE SPREADING THE TOPSOIL. REMOVE ALL DEBRIS AND LEAVE A FINE-TEXTURED EVEN SURFACE. ALL TOPSOIL TO BE IMPORTED UNLESS PREVIOUSLY APPROVED BY LANDSCAPE ARCHITECT. OBTAIN APPROVAL FOR THE QUALITY OF ANY IMPORTED TOPSOIL BEFORE DELIVERY TO THE SITE. TOPSOIL IS TO BE COMPACTED TO CREATE A FIRM AND EVEN SURFACE.

USE NO. 1 GRADE TURFGRASS NURSERY SOD WHICH CONFORMS WITH THE SPECIFICATIONS OF THE NURSERY SOD GROWERS ASSOCIATION OF ONTARIO. ALL LAWN AREAS SHALL RECEIVE A MINIMUM OF 100MM (4") OF COMPACTED TOPSOIL, AND SHALL BE SODDED WITH #1 KENTUCKY BLUEGRASS - FESCUE. NO SOD SLOPES ARE TO EXCEED 3:1. SLOPE IN EXCESS OF 4:1 TO BE PEGGED

#### MINERAL FERTILIZER

APPLY THE FOLLOWING MINERAL FERTILIZER UNLESS SOILS TESTS SHOW OTHER REQUIREMENTS:

1. SODDED AREAS - 11% NITROGEN, 8% PHOSPHORUS AND 4% POTASH (11-8-4) AT THE RATE OF 4.5 KG OVER M2 (10 LBS OVER 1000 SQ.

2. PLANTING BEDS - 7% NITROGEN. 7% PHOSPHORUS AND 7% POTASH (7-7-7) AT THE RATE OF 40 GRAMS (4 OZ.) FOR EVERY BUSHEL OF

#### PREPARATION OF PLANTING BEDS

ALL PLANT BEDS TO BE CONTINUOUS. EXCAVATE ALL PLANTING BEDS TO THE DEPTH AS INDICATED ON THE DRAWINGS AND DETAILS, MIN 450mm(18") BACKFILL ALL PLANTING BEDS WITH A SOIL MIXTURE CONSISTING OF SIX (6) PARTS OF SAND LOAM ONE (1) PART OF FINELY PULVERIZED PEAT MOSS, TWO (2) PARTS OF WELL-ROTTED MANURE AND THE MINERAL FERTILIZER AS SPECIFIED ABOVE. ALSO ADD .58 KILOS BONEMEAL/CUBIC METER OF PLANTING SOIL (1 LB /CUBIC YARD). PREPARE THE PLANTING BEDS FOR PLANTING BEFORE THE DELIVERY OF THE PLANT MATERIAL TO THE JOB SITE.

NOTE: IF THE EXISTING SOIL CONDITIONS ARE CLAY OR WET IN NATURE, CONTACT THE LANDSCAPE ARCHITECT FOR INSTRUCTIONS OF A SUITABLE SOIL MIXTURE. FAILURE TO DO THIS MAY RESULT IN DELAY OF APPROVAL AND ACCEPTANCE.

ALL PLANT MATERIAL SHALL CONFORM TO THE STANDARDS OF THE CANADIAN NURSERY TRADES ASSOCIATION FOR SIZE AND

OF PLANTING OPERATIONS. ALL PLANT MATERIAL TO BE CLAY GROWN STOCK UNLESS OTHERWISE NOTED.

ALL SHRUB AND TREE MATERIAL SHALL BE CONTAINER GROWN, POTTED, S/B OR B/B, UNLESS OTHERWISE NOTED. BARE ROOT PLANTING SHALL BE ACCEPTABLE FOR CERTAIN SPECIES DURING EARLY SPRING OR LATE FALL PLANTING SEASON. CONTRACTOR SHALL MAKE REQUESTS FOR ROOT CONDITION SUBSTITUTION IN WRITING TO THE LANDSCAPE ARCHITECT PRIOR TO COMMENCEMENT

### LANDSCAPE SPECIFICATIONS

SCALE: N.T.S. DATE:

PLANT MATERIALS



#### PLANT MATERIAL INSTALLATION

ALL TREES, SHRUBS AND GROUNDCOVERS SHALL BE PLANTED AS DETAILED & AS SHOWN ON THE PLANTING PLAN. ALL BEDS TO RECEIVE A COVER OF CLEAN MULCH TO A DEPTH OF 75mm(3"). FOR GUYING AND STAKING TREES, REFER TO PLANTING DETAILS. WRAP ALL DECIDUOUS TREES UNDER EXPERIENCED SUPERVISION ONLY TO THE SPECIFICATIONS OF THE ONTARIO LANDSCAPE CONTRACTORS ASSOCIATION.

#### PLANT MATERIAL SIZES AND CONDITIONS ARE TO BE AS INDICATED ON THE LANDSCAPE DRAWING.

THE INDIVIDUAL PLANT GROUPING TOTAL AS ILLUSTRATED ON THE PLANTING PLAN SUPERSEDES THE ESTIMATED QUANTITY ON THE MASTER PLANT LIST. CONTRACTOR MUST REPORT ANY DISCREPANCIES TO THE LANDSCAPE ARCHITECT IN WRITING BEFORE COMMENCING ANY WORK. CONTRACTOR WILL ASSUME FULL RESPONSIBILITY IF LANDSCAPE ARCHITECT IS NOT NOTIFIED. OF

\* MULCH - SHREDDED PINE MULCH BY "GRO BARK" OR APPROVED EQUAL. LANDSCAPE ARCHITECT TO APPROVE MULCH BEFORE INSTALLATION.

### GENERAL MAINTENANCE

PROPER MAINTENANCE PROCEDURES ARE TO BE FULLY ADMINISTERED FOR ALL NEWLY CONSTRUCTED LANDSCAPE WORK, IN ACCORDANCE WITH LANDSCAPE ONTARIO SPECIFICATIONS (SECTION 1E - MAINTENANCE WORK). THIS SHALL APPLY ONLY DURING THE CONSTRUCTION PERIOD, UNLESS OTHERWISE SPECIFIED. CONTRACTOR IS RESPONSIBLE FOR MAINTENANCE OF SOD AND PLANTING UNTIL FINAL ACCEPTANCE BY LANDSCAPE ARCHITECT.

RODENT PROTECTION THE CONTRACTOR SHALL BE RESPONSIBLE FOR THE PROTECTION OF ALL TREES AND SHRUBS FOR WINTER PROTECTION AND FROM RODENT INJURY FOR THE DURATION OF GUARANTY PERIOD. PROTECTIVE GUARDS SHALL BE EMPLOYED AROUND ALL DECIDUOUS

TREES. GUARDS TO BE 150MM DIA. PVC PIPE OR AS MUNICIPAL GUIDELINES. GUARDS SHALL BE INSTALLED PRIOR TO THE

APPLICATION OF THE MULCH AND SHOULD BE PLACED A MINIMUM OF 50MM (2") OUT FROM THE TREE TRUNK ON ALL SIDES.

ALL SHRUBS AND CONIFEROUS TREES SHALL HAVE AN APPLICATION OF "SKOOT" OR APPROVED EQUIVALENT RODENT FORMULA, TO BE APPLIED AT THE END OF OCTOBER. FOLLOW MANUFACTURER'S DIRECTIONS FOR APPLICATION.

### GENERAL REQUIREMENTS


USE ABOVE SPECIFICATIONS IN CONJUNCTION WITH THE GENERAL LANDSCAPE SPECIFICATIONS OF THE ONTARIO LANDSCAPE CONTRACTORS ASSOCIATION. THE NURSERY SOD GROWERS ASSOCIATION OF ONTARIO AND WITH THE GUIDE SPECIFICATIONS FOR NURSERY STOCK OF THE CANADIAN NURSERY TRADES ASSOCIATION. USE ONLY PLANT MATERIAL TRUE TO NAME, SIZE AND GRADE AS SPECIFIED ON PLANTING PLAN: PROVIDE SUFFICIENT LABELS OR MARKINGS TO INDICATE CLEARLY THE VARIETY. SIZE AND GRADE OF FACH SPECIMEN OR BUNDLE


OBTAIN APPROVAL FOR SUBSTITUTIONS AS TO VARIETY, SIZE OR GRADE FROM THE LANDSCAPE ARCHITECT. USE ONLY NURSERY STOCK GROWN UNDER PROPER HORTICULTURAL PRACTICES, VIABLE, FREE FROM PEST AND DISEASE AND UNDAMAGED. CHECK LOCATIONS AND OBTAIN STAKEOUTS OF ALL UTILITY LINES BEFORE EXCAVATION, OBTAIN ALL NECESSARY PERMITS BEFORE COMMENCEMENT OF CONSTRUCTION, REPORT IN WRITING ANY DISCREPANCIES IN THE DRAWINGS, SPECIFICATIONS AND CONTRACT DOCUMENTS TO THE LANDSCAPE ARCHITECT BEFORE THE END OF THE BIDDING PROCESS AND COMMENCEMENT OF CONSTRUCTION. THESE SPECIFICATIONS MAY BE SUPERCEDED BY ADDITIONAL SPECIFICATIONS SET OUT IN THE TENDER DOCUMENTS. CONTRACTOR TO REVIEW ALL DOCUMENTS.

PROVIDE ONE FULL YEAR GUARANTEE ON ALL LANDSCAPE WORK FROM DATE OF FINAL ACCEPTANCE BY LANDSCAPE ARCHITECT. GUARANTEE PERIOD MAY BE EXTENDED TO TWO FULL YEARS DEPENDING ON MUNICIPAL STANDARDS. CONTRACTOR TO VERIFY WITH

## PLANT MATERIAL INSTALLATION


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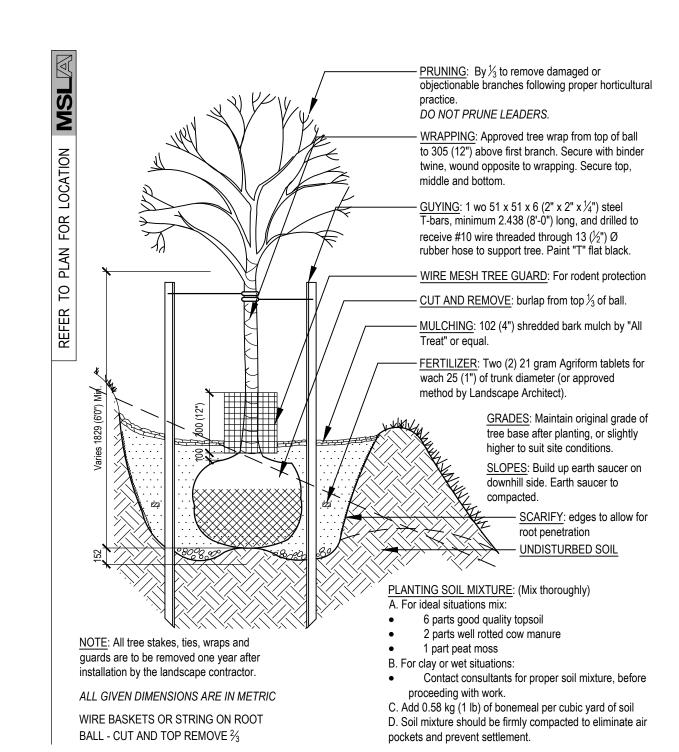


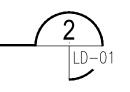
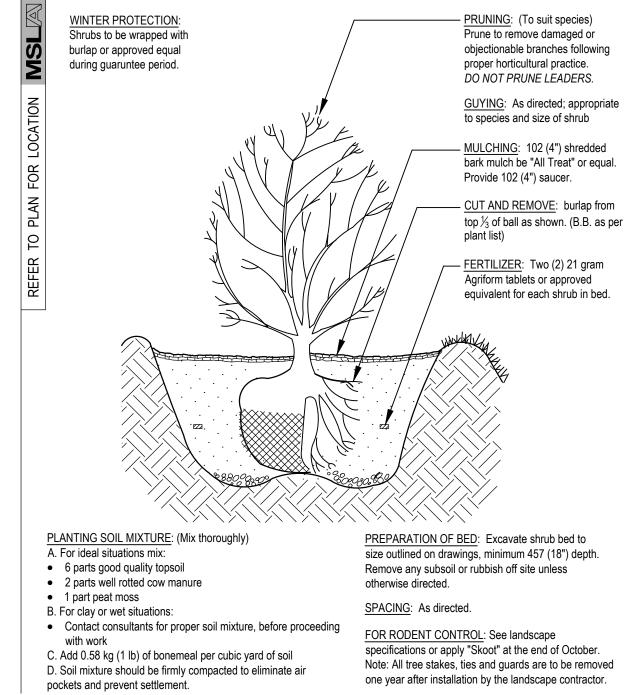
# STANDARD SHRUB PLANTING DETAIL


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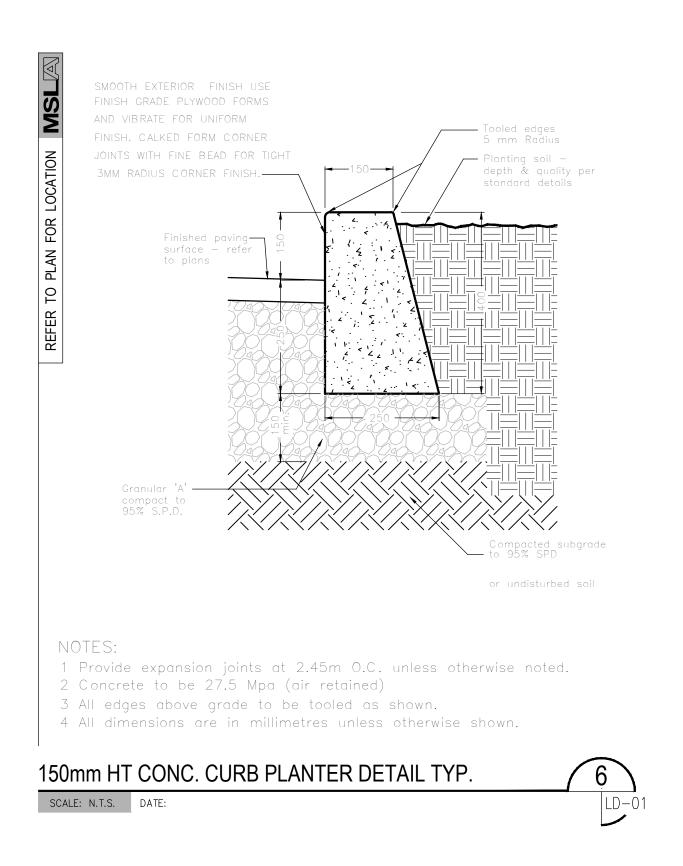


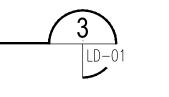



# STANDARD DECIDUOUS TREE DETAIL


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07 Issued for SPA 02/17/22 06 Issued for Submission 12/02/21 11/09/21 05 Issued for Review 11/01/21 04 Issued for Review 09/23/21 03 Revised per Comments 09/22/21 02 Revised per Comments 07/26/21 01 Issued for Review No. Revision Date

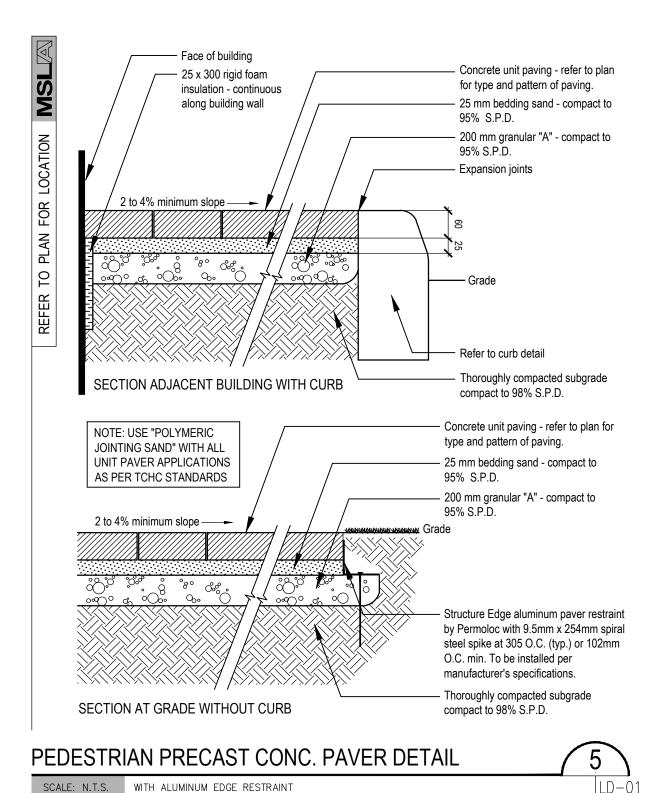


Project: Proposed Landscape and Site Upgrades 101 - 111 Edgehill Drive

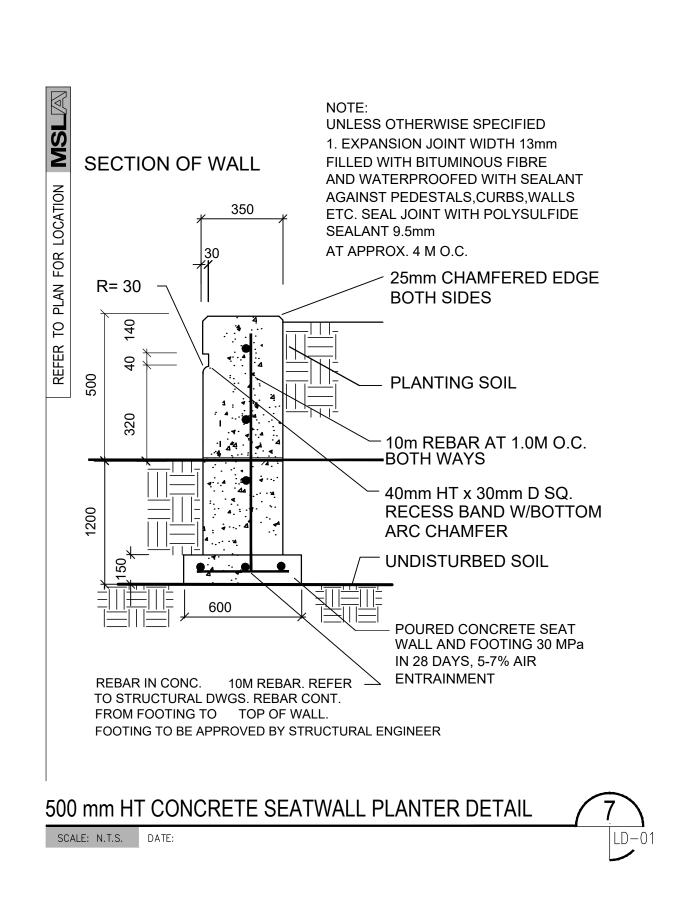
Barrie, Ontario **1:250** Date: Scale: Jul 2021 Drawn By: **S.P** Checked By: **L.M.** 

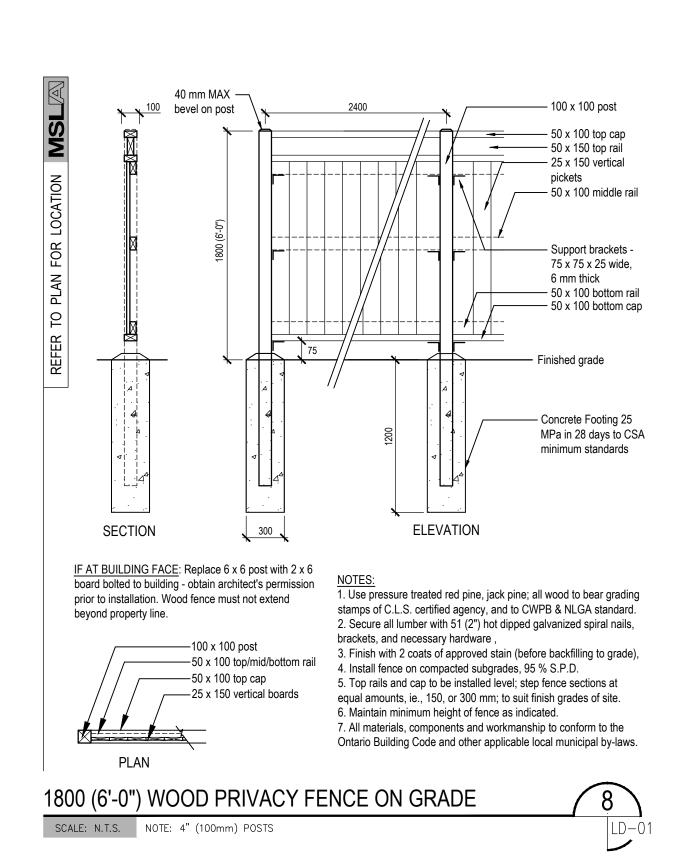
Drawing Title: Landscape **Details** 

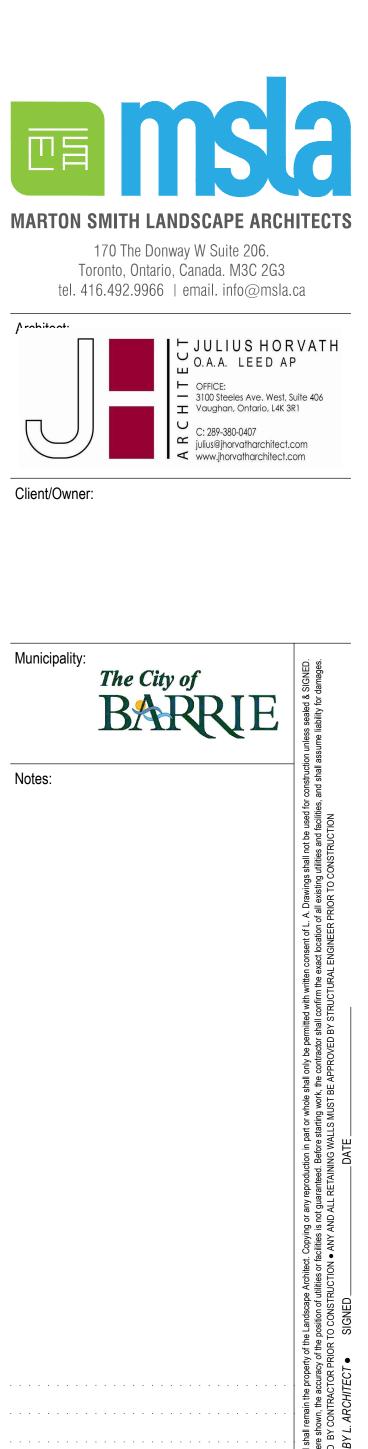Project No.

**LD-01** 

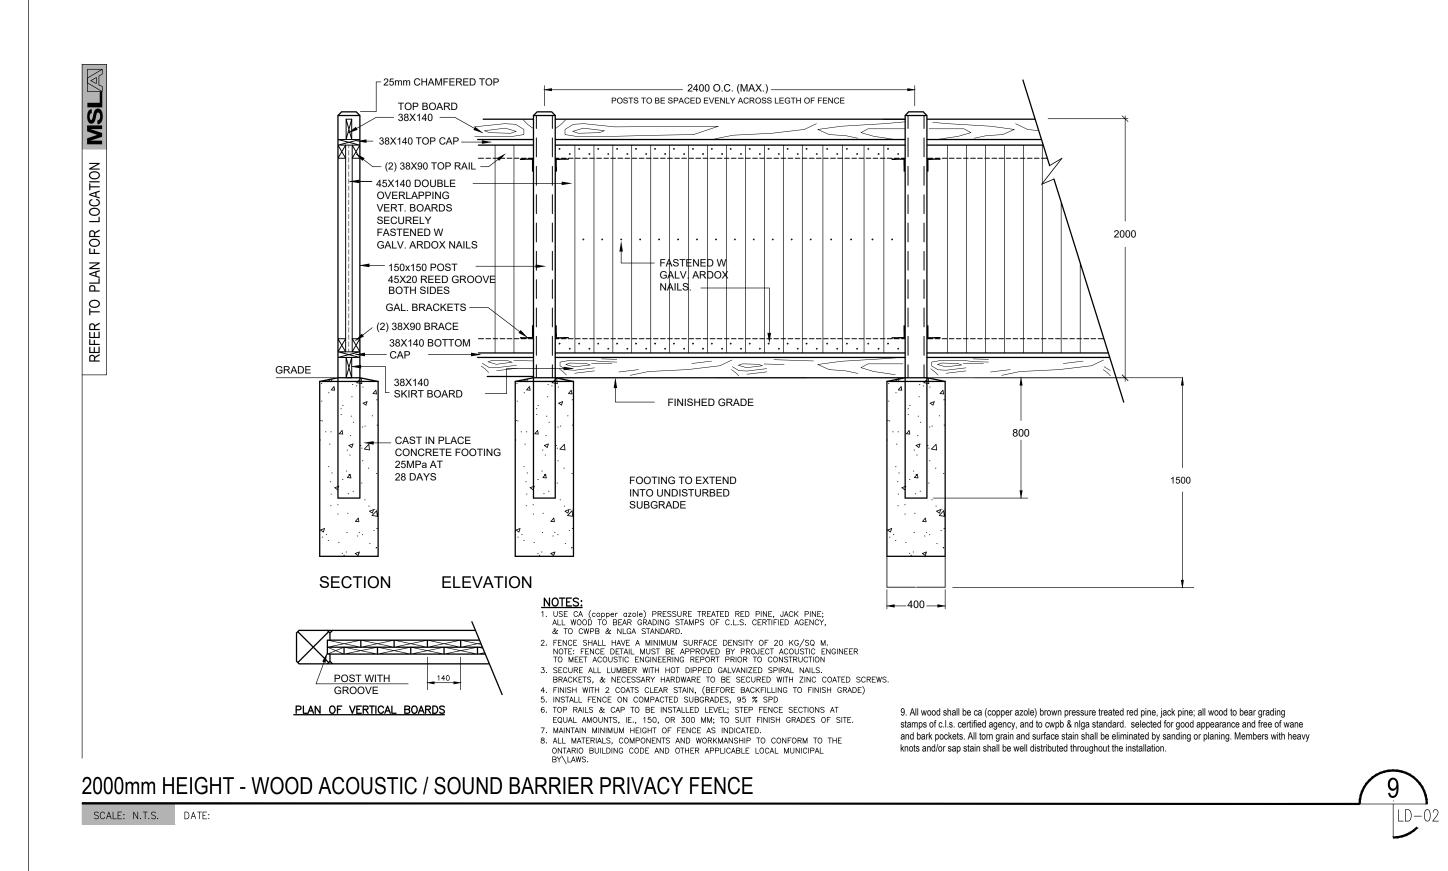


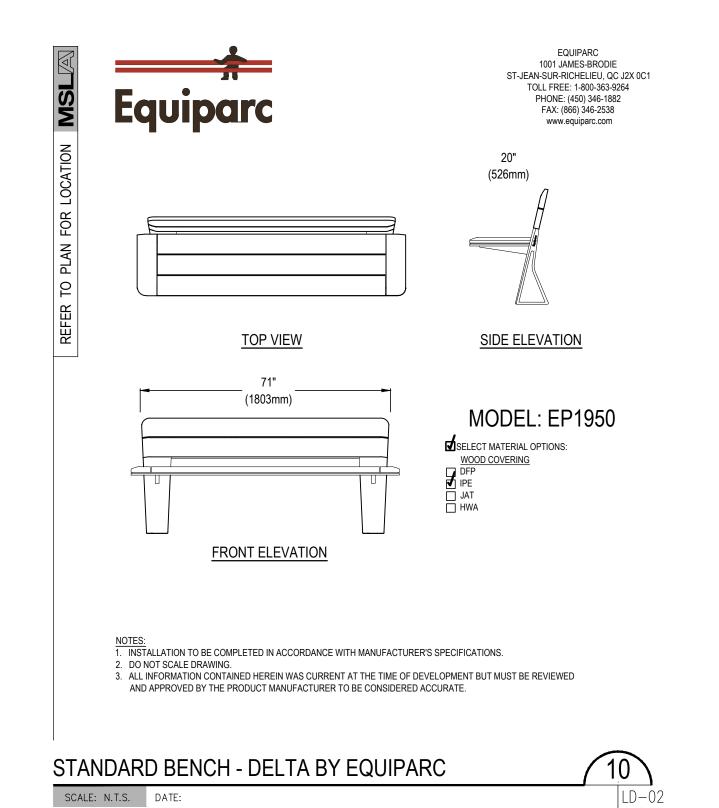


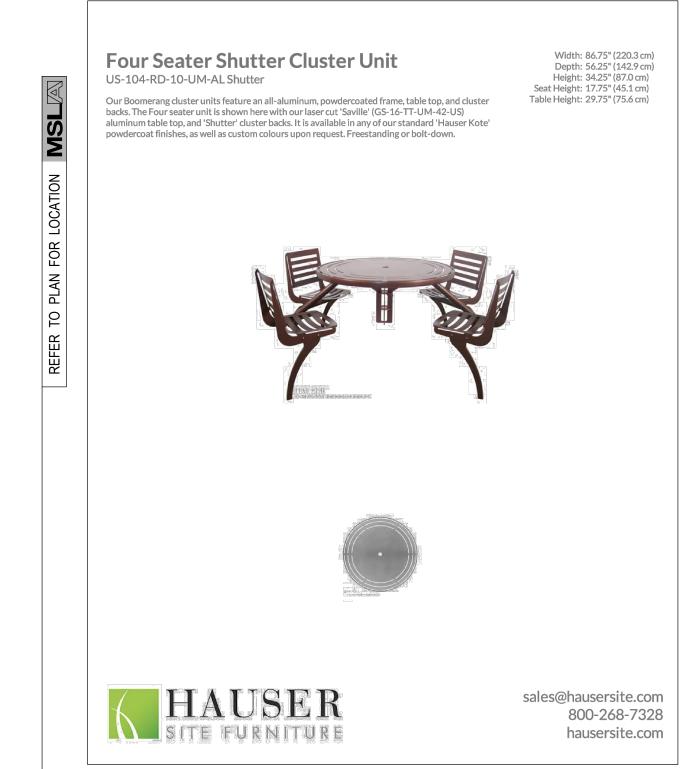


HAUSER CLUSTER SEATING

SCALE: N.T.S. DATE:

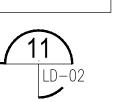

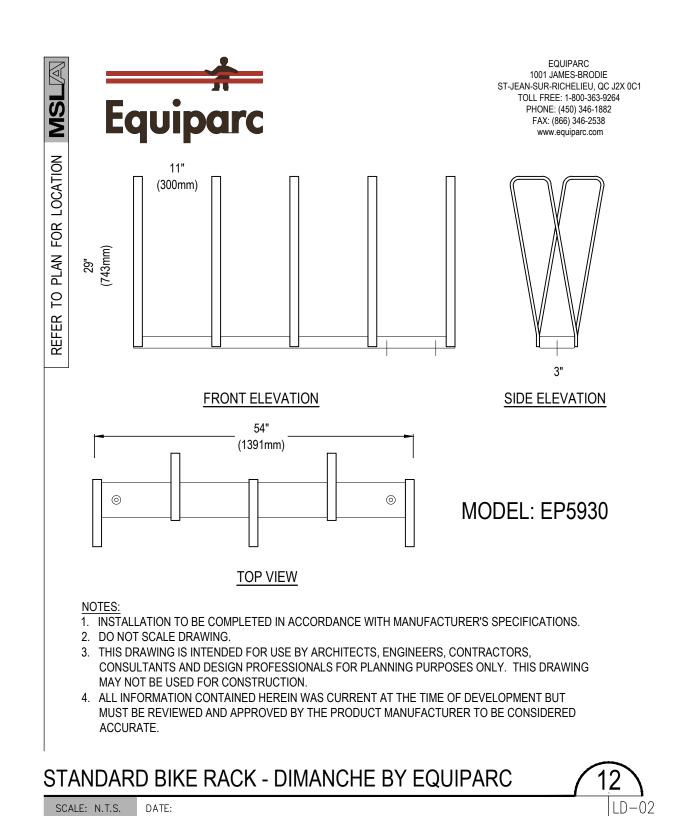



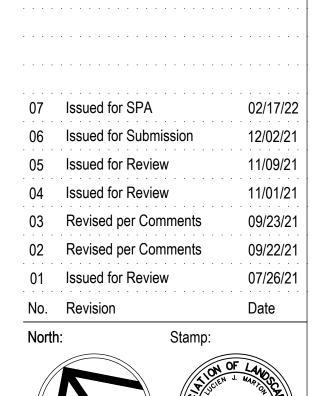

**MARTON SMITH LANDSCAPE ARCHITECTS** 

170 The Donway W Suite 206.

Toronto, Ontario, Canada. M3C 2G3

tel. 416.492.9966 | email. info@msla.ca

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└ JULIUS HORVATH

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O.A.A. LEED AP

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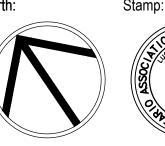
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Client/Owner:

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Proposed Landscape and Site Upgrades 101 - 111 Edgehill Drive

Barrie, Ontario **1:250** Date: **Jul 2021** 

S.P Checked By: L.M. Drawn By: Drawing Title:

Landscape **Details** 

Project No. **LD-02**