

- GRADE AND THEN ADJUSTED TO FINAL GRADE WHEN THE TOP LIFT OF ASPHALT IS PLACED. ALL ADJUSTMENT WILL BE ACCORDANCE WITH BSD-N2.
- E. STORM SEWER TO BE LOCATED OFFSET 3.0m SOUTH OR EAST OF CENTRELINE UNLESS OTHERWISE SPECIFIED.
- F. ALL CONNECTIONS TO THE STORM MAIN SHALL BE MADE WITH A STORM MANHOLE OR APPROVED FACTORY TEE CONNECTION AS PER OPSD-708.01 OR 708.03.
- G. PIPE MATERIAL TO BE REINFORCED CONCRETE WITH A MINIMUM STRENGTH OF 50 N/m/mm CERTIFIED TO C.S.A. STANDARD A247.2-1982, CLASS 50-D (PREVIOUSLY C.S.A. STANDARD A257.2-1974, CLASS II) OR PVC CERTIFIED TO C.S.A. STANDARDS 182.2 AND 182.4.
- H. STORM SEWER TO BE MINIMUM 300mm DIAMETER WITH JOINTS CONFORMING TO

INSTALLATION GUIDES AND THE O.C.P.A. OR UNIBELL GUIDELINES.

- I. ALL PIPE BEDDING MUST CONFORM TO OPSD, MAXIMUM COVER TABLE. NO FLEXIBLE PIPE SEWERS WILL BE INSTALLED WITH A DEPTH OF COVER GREATER THAN 6 METRES UNLESS SPECIFICALLY APPROVED BY THE DIRECTOR OF ENGINEERING.
- J. ALL PIPE HANDLING INSTALLATIONS MUST BE IN STRICT COMPLIANCE WITH MANUFACTURES

C.S.A. STANDARD A257.3.

K. SUMP PUMP DISCHARGE PIPING IN BOULEVARD: IN THE EVENT OF OVERACTIVE SUMP PUMP ACTIVITY, A 150mm DIAMETER PVC DR-28 SEWER MAY BE INSTALLED, WHEN SO DIRECTED BY THE DIRECTOR OF ENGINEERING, ALONG THE FRONTAGES OF DESIGNATED LOTS, WITH AN OFFSET OF 0.6m FROM BACK OF CURB. THIS SEWER IS TO BE CAPPED AT THE UPSTREAM END AND IS TO OUTLET INTO THE NEAREST CATCHBASIN DOWNSTREAM. DEPTH OF SEWER IS TO BE EQUAL TO SUBDRAIN DEPTH. NOT TO BE DIRECTLY CONNECTED TO FOUNDATION DRAINS.

CITY OF BARRIE STANDARD	4.	NOTE 'K' - SUMP PUMP DISCHARGE PIPING	B.R.	2003.01.07	APR'D:	RGN	DATE:	92.05.15
	3.	NOTE 'I' & 'C' - "DIRECTOR OF ENGINEERING"	B.R.	2002.10.28		11.0.11.	DATE.	32.03.10
CENEDAL NOTES	2.	NOTE 'C' OPSD NUMBER REVISION	K.C.	2000.03.16	DRAWN:	L.A.J.	SCALE:	N.T.S.
GENERAL NOTES	1.	NOTE 'D' CHANGED	K.C.	98.03.30				
STORM SEWERS	NO.	REVISION	APR'D	DATE		BSD	-N5	

GENERAL NOTES - WATERMAIN

1. CONTRACTORS SHALL INFORM THE CITY OF BARRIE WATER OPERATIONS DEPARTMENT A MINIMUM OF 48 HOURS IN ADVANCE OF THEIR INTENTIONS TO PERFORM WORK ON WATER INFRASTRUCTURE.

2. OPERATION OF HYDRANTS AND VALVES ON THE POTABLE WATER SYSTEM BY OTHER THAN QUALIFIED WATER OPERATIONS STAFF IS PROHIBITED BY CURRENT BY-LAW. CITY SERVICE FEES ARE PER THE CURRENT FEES BY-LAW. THE CITY'S WATER OPERATIONS STAFF WILL SWAB, PRESSURE TEST, CHLORINATE AND FLUSH ALL NEW WATERMAINS.

3. MINIMUM COVER OVER WATERMAIN SHALL BE 1.7m. THE MINIMUM HORIZONTAL SEPARATION BETWEEN WATERMAIN AND SEWERS SHALL BE 2.5m. WHERE WATERMAIN CONFLICTS WITH SEWER PIPES, DEFLECT WATERMAIN HORIZONTALLY OR VERTICALLY WHILE PROVIDING A MINIMUM OF 0.5m CLEARANCE BETWEEN WATERMAIN AND SEWERS. MAINTAIN MINIMUM DEPTH OF COVER AT ALL TIMES.

4. WATERMAIN SHALL BE INSTALLED IN BEDDING AS PER OPSD 802.010 (GRANULAR 'A' EMBEDMENT MATERIAL) FOR FLEXIBLE PIPES AND OPSD 802.030 OR 802.031 CLASS 'B' (GRANULAR 'A' BEDDING MATERIAL, GRANULAR 'A' OR SELECT NATIVE COVER MATERIAL) FOR RIGID PIPE UNLESS OTHERWISE APPROVED BY THE DIRECTOR OF WATER OPERATIONS. ALTERNATIVE EMBEDMENT MATERIAL - SAND MEETING GRADATION REQUIREMENTS OF OPSS.MUNI 1004.05.07 COMPACTED TO 95% STANDARD PROCTOR MAXIMUM DRY DENSITY IS PERMISSIBLE WHERE NOTED IN STANDARD DETAILS. GEOTECHNICAL CERTIFICATION OF MATERIAL AND COMPACTION TESTING MUST BE PROVIDED EVERY 150 METRES. THE

5. COPPER WATER MAINS AND SERVICES 25mm TO 50mm IN DIAMETER SHALL BE EMBEDDED IN SAND 100mm ABOVE AND BELOW TO CONFORM TO

COMPACTION TESTING MUST INCLUDE THE ENTIRE EMBEDMENT ENVELOPE (HAUNCHES, BEDDING, TOP OF PIPE AND COVER).

6. RESTRAINING WILL BE REQUIRED ON ALL HYDRANTS, THRUST BLOCKS, AS PER OPSD 1103,010 AND 1103,020, RESTRAINING DEVICES MAY BE REQUIRED IN ADDITION TO STANDARD CONCRETE THRUST BLOCKING WHERE SOIL CONDITIONS WARRANT AT THE CITY'S DISCRETION. 7. NEW WATERMAINS TO BE PVC DR18 CL150 MINIMUM; DUCTILE IRON CL52 AS PER THE APPROVED MANUFACTURERS PRODUCTS FOR LINEAR

8. TRACING WIRE SHALL BE #12 AWG HIGH STRENGTH COPPER CLAD (HS-CSS) AND SHALL BE INSTALLED ON THE TOTAL LENGTH OF ALL WATERMAIN AND BROUGHT UP AT EACH HYDRANT AND CONNECTED TO FLANGE BOLT. ALL SPLICES TO UTILIZE CONNECTORS AS PER THE APPROVED

MANUFACTURERS PRODUCTS FOR LINEAR WATER SYSTEMS LIST. 9. ALL WATER SERVICES SHALL BE MINIMUM 25mm TYPE 'K' COPPER OR 25mm CROSS-LINKED POLYETHYLENE UNLESS OTHERWISE APPROVED BY

THE DIRECTOR OF WATER OPERATIONS. WATER SERVICE SADDLES SHALL BE USED WHEN TAPPING INTO PVC WATERMAIN. 10. SERVICE TAPPINGS SHALL BE PLACED AT A MINIMUM SEPARATION OF 1.0m AND A MINIMUM OF 0.6m FROM JOINTS. (ENDS OF PIPE)

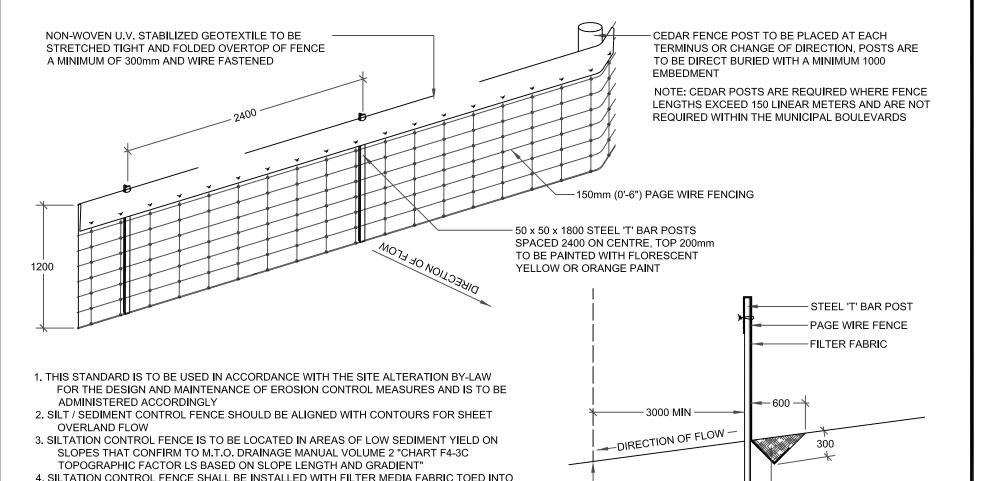
11. RISER PIPES ARE TO BE INSTALLED AS PER BSD-510, AND REMOVED AS DIRECTED. SWABBING SCHEDULE TO BE SUPPLIED BY A WATER OPERATIONS FIELD REPRESENTATIVE. ALL RISERS ARE TO BE RESTRAINED OR THRUST BLOCKED.

12. ALL NEW CURB STOPS AND BOXES TO BE LOCATED AT PROPERTY. LINE AND OUT OF DRIVEWAYS AND SIDEWALKS.

GENERAL NOTES - WATERMAIN

REV No. DATE: MAY 2015 SCALE: N.T.S. BSD-500

Limitador



Barrie SILTATION CONTROL **FENCING** STANDARD DETAIL

THE SOIL 300mm BE EITHER STATIC SLICING OR TRENCHING METHODS WITH

6. SILT / SEDIMENT CONTROL FENCE MAY BE UTILIZED FOR TREE PRESERVATION AND IS TO

COMPACTION OF TRENCH MATERIAL MEETING 95% S.P.D.

5. ALL DIMENSIONS ARE IN MILLIMETRES UNLESS OTHERWISE SHOWN

BE USED IN CONJUNCTION WITH BSD-1231, BSD-1232 AND BSD-1235

SCALE: N.T.S. FORMERLY BSD-23A

- PROPERTY LIMIT OR

TOP OF BANK

APPROVED

SOIL OR CLEAR STONE

DIRECTOR OF ENGINEERING

GENERAL NOTES

1. DRAWINGS

A. ALL DRAWINGS SHALL BE PRODUCED IN ACCORDANCE WITH CURRENT CITY OF BARRIE STANDARDS & SYMBOLS FOR PLAN & PROFILE DRAWINGS, GENERAL SERVICE PLANS AND LOT GRADING PLANS.

2. MEASUREMENTS

A. ALL DIMENSIONS ARE IN METRES, EXCEPT PIPE DIAMETERS, WHICH ARE IN MILLIMETRES, UNLESS SPECIFIED OTHERWISE.

- A. ALL WORK SHALL BE IN ACCORDANCE WITH CURRENT CITY OF BARRIE STANDARD DRAWINGS (BSD) AND ONTARIO PROVINCIAL STANDARD DRAWINGS (OPSD).
- B. ORDER OF PRECEDENCE OF STANDARD DRAWINGS IS FIRSTLY CITY OF BARRIE STANDARD DRAWINGS (BSD) AND SECONDLY ONTARIO PROVINCIAL STANDARD DRAWINGS (OPSD).
- C. LOCATION OF EXISTING SERVICES ARE NOT GUARANTEED.
- THE CONTRACTOR IS REQUIRED TO NOTIFY THE VARIOUS UTILITY COMPANIES 48 HOURS PRIOR TO THE COMMENCEMENT OF ANY WORK.
- D. A ROAD OCCUPANCY PERMIT IS REQUIRED FROM THE ROADS AND PARKS OPERATIONS BRANCH PRIOR TO THE COMMENCEMENT OF WORK WITHIN ANY CITY RIGHT-OF-WAY.
- E. A SITE ALTERATION PERMIT IS REQUIRED FROM THE ENGINEERING DEPARTMENT PRIOR TO THE COMMENCEMENT OF ANY EARTH WORKS ON THE SITE.
- F. NATIVE MATERIAL, SUITABLE FOR BACKFILL, SHALL BE COMPACTED TO 95% STANDARD PROCTOR MAXIMUM DRY DENSITY.
- G. GRANULAR MATERIAL , USED FOR BACKFILL , SHALL BE PLACED IN LAYERS 150mm IN DEPTH MAXIMUM AND COMPACTED TO 100% STANDARD PROCTOR MAXIMUM DRY DENSITY.
- H. ALL DISTURBED AREAS ARE TO BE REINSTATED TO THEIR ORIGINAL CONDITION OR BETTER,

AS DETERMINED BY THE CITY ENGINEERING DEPARTMENT.

SUBJECT TO APPROVAL BY THE CITY ENGINEERING DEPARTMENT.

I. ALL SILT CONTROL AND EROSION PROTECTION DEVICES ARE TO BE IN PLACE PRIOR TO THE COMMENCEMENT OF CONSTRUCTION AND SHALL REMAIN IN PLACE AND BE MAINTAINED BY THE CONTRACTOR UNTIL CONSTRUCTION IS COMPLETE AND THE GRASS HAS ESTABLISHED GROWTH,

CITY OF BARRIE STANDARD					APR'D:	R.G.N.	DATE:	92.05.15
GENERAL NOTES	3.	3. NOTE: 3.E. REVISED & 3.I. ADDED	J.S.	05.01.10				
	2.	3.D. — "ENGINEERING DEPARTMENT"	B.R.	02.10.28	DRAWN:	L.A.J.	SCALE:	N.T.S.
	1.	3.E. TOPSOIL PERMIT		01.12.06				
	NO.	REVISION	APR'D	DATE				

GENERAL NOTES - SANITARY SEWER

SANITARY SEWERS

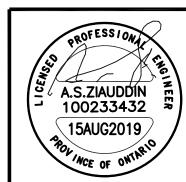
- A. SANITARY SEWER TO BE LOCATED AT THE CENTRELINE OF THE ROAD.
- B. SEWERS SHALL BE CONSTRUCTED WITH BEDDINGS AS PER OPSD-802.010, (GRAN. 'A' EMBEDMENT MATERIAL) FOR FLEXIBLE PIPES AND OPSD-802.030 OR 802.031 CLASS B (GRAN. 'A' BEDDING MATERIAL) FOR RIGID PIPE UNLESS OTHERWISE APPROVED BY THE DIRECTOR OF ENGINEERING.
- C. MAXIMUM DEFLECTION FROM COMBINED LIVE AND DEAD LOADING SHALL NOT EXCEED ANY C.S.A., O.P.S. OR MANUFACTURERS RECOMMENDED SPECIFICATIONS.
- D. PVC. CONCRETE AND PROFILE WALL PVC SEWERS SHALL HAVE RUBBER GASKET TYPE JOINTS AND SHALL BE CERTIFIED TO CONFORM TO ALL APPLICABLE CURRENT C.S.A. SPECIFICATIONS.
- E. CONCRETE SANITARY SEWERS SHALL HAVE A MINIMUM STRENGTH OF 50 N/m/mm CONFORMING TO CSA STANDARD A257.2-1982, CLASS 50-D (PREVIOUSLY C.S.A. STANDARD A257.2-1974, CLASS II).
- F. MAINTENANCE HOLE TOPS (FRAMES) ARE TO BE SET TO BASE COURSE ASPHALT GRADE AND THEN ADJUSTED TO FINAL GRADE WHEN THE TOP LIFT OF ASPHALT IS PLACE. ALL ADJUSTMENT WILL BE ACCORDANCE WITH BSD-N2.
- G. ALL CONNECTIONS TO NEW SANITARY MAINS SHALL BE PRE-MANUFACTURED, FABRICATED TEES. CONNECTIONS TO EXISTING SANITARY SEWER SHALL BE MADE WITH APPROVED FACTORY MADE TEES OR INSERTA-TEES IN STRICT ACCORDANCE TO MANUFACTURES GUIDELINES

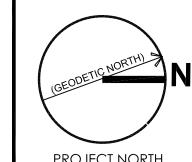
CITY OF BARRIE STANDARD	4.	NOTE 'B' - "ENGINEERING"	B.R.	2002.10.28		R.G.N.	DATE	92.05.15
		NOTE 'B' OPSD NUMBER REVISION	K.C.	2000.03.16	APR'D:	11.G.IV.	DATE:	
GENERAL NOTES	2.	NOTE 'F' CHANGED	K.C.	98.03.30	DRAWN:	L.A.J.	SCALE:	N.T.S.
	1.	CHANGES TO B. TO G.	K.C.	95.04.24				
SANITARY SEWERS	NO	DEMICION	, DD'D	DATE	BSD-N3			
	NO.	REVISION	IAPRU	DATE				



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THIS DRAWING TO BE READ WITH CONJUCTION OI OTHER CIVIL DRAWINGS, ARCHITECTURAL SITE PLAN, MECHANICIAL & PLUMBING DRAWINGS

1	15 AUG. 2019	ISSUED FOR SPA	ΑZ
No.	Date	Version	Dwn

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| PROPOSED ADDITION TO FAIRFIELD INN AND **SUITES (MARRIOTT) 261 ESSA ROAD** BARRIE, ONTARIO

DRAWING TITLE:

DETAIL STANDARDS

SCALE: 1:350 CHECKED BY: AZ DRAWING NO .:

PROJECT NO.:

13-15

DRAWN BY: AZ

C4

DATE: 15 MAY. 2019