



LEGEND

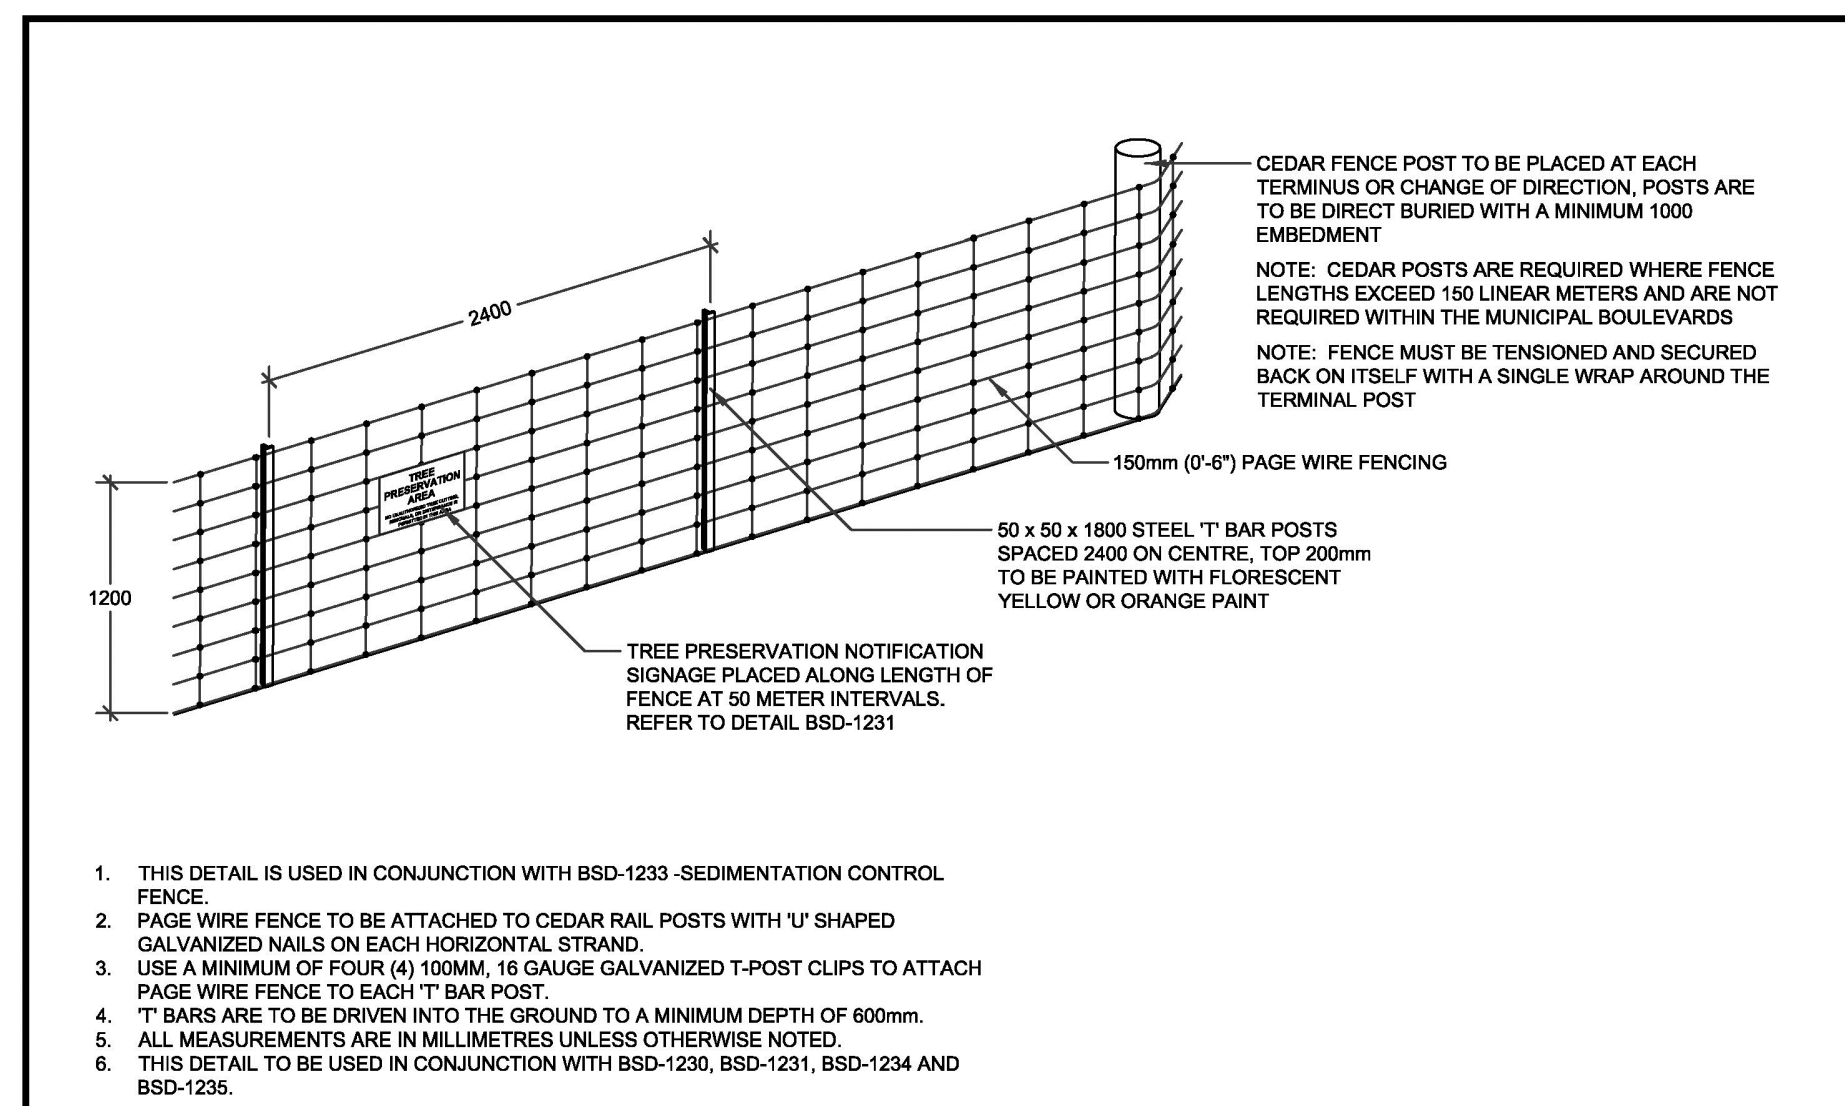


1. THIS DETAIL IS USED IN CONJUNCTION WITH BSD-1233 - SEDIMENTATION CONTROL FENCE.
2. PAGE WIRE FENCE TO BE ATTACHED TO CEDAR RAIL POSTS WITH 'U' SHAPED GALVANIZED NAILS ON EACH HORIZONTAL STRAND.
3. USE A MINIMUM OF FOUR (4) 100MM, 16 GAUGE GALVANIZED T-POST CLIPS TO ATTACH PAGE WIRE FENCE TO EACH T BAR POST.
4. T BARS ARE TO BE DRIVEN INTO THE GROUND TO A MINIMUM DEPTH OF 600mm.
5. ALL MEASUREMENTS ARE IN MILLIMETRES UNLESS OTHERWISE NOTED.
6. THIS DETAIL TO BE USED IN CONJUNCTION WITH BSD-1230, BSD-1231, BSD-1234 AND BSD-1235.

<p>STANDARD DETAIL</p>	<p>TREE PRESERVATION FENCING</p>	REV No. 1 DATE: JUNE 2015 SCALE: N.T.S.	APPROVED DATE: DIRECTOR OF ENGINEERING
		BSD-1232	
		DIRECTOR OF ENGINEERING	

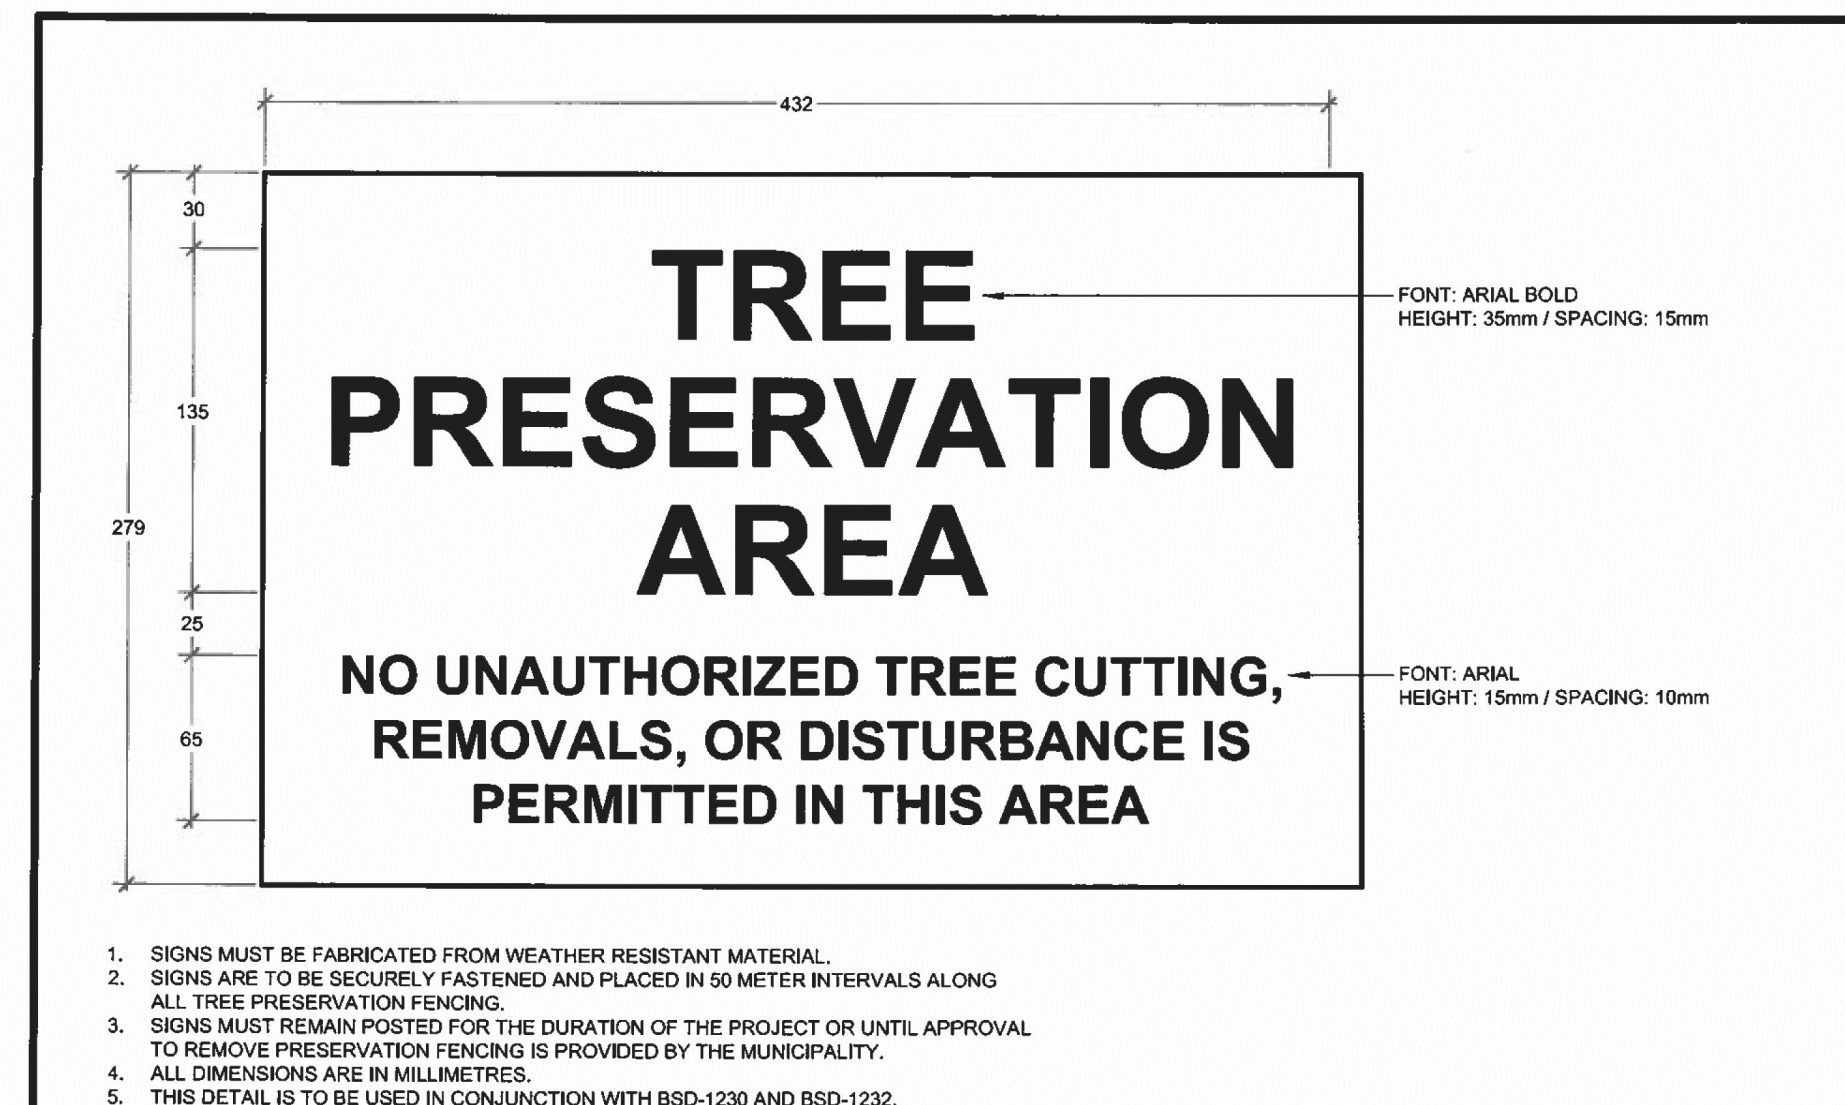

1. SIGNS MUST BE FABRICATED FROM WEATHER RESISTANT MATERIAL.
2. SIGNS ARE TO BE SECURELY FASTENED AND PLACED IN 50 METER INTERVALS ALONG ALL TREE PRESERVATION FENCING.
3. SIGNS MUST REMAIN POSTED FOR THE DURATION OF THE PROJECT OR UNTIL APPROVAL TO REMOVE PRESERVATION FENCING IS PROVIDED BY THE MUNICIPALITY.
4. ALL DIMENSIONS ARE IN MILLIMETRES.
5. THIS DETAIL IS TO BE USED IN CONJUNCTION WITH BSD-1230 AND BSD-1232.

<p>STANDARD DETAIL</p>	<p>TREE PRESERVATION AREA TEMPLATE</p>	REV No. 1 DATE: JUNE 2015 SCALE: N.T.S.	APPROVED DATE: June 11, 2015 DIRECTOR OF ENGINEERING
		BSD-1231	
		DIRECTOR OF ENGINEERING	

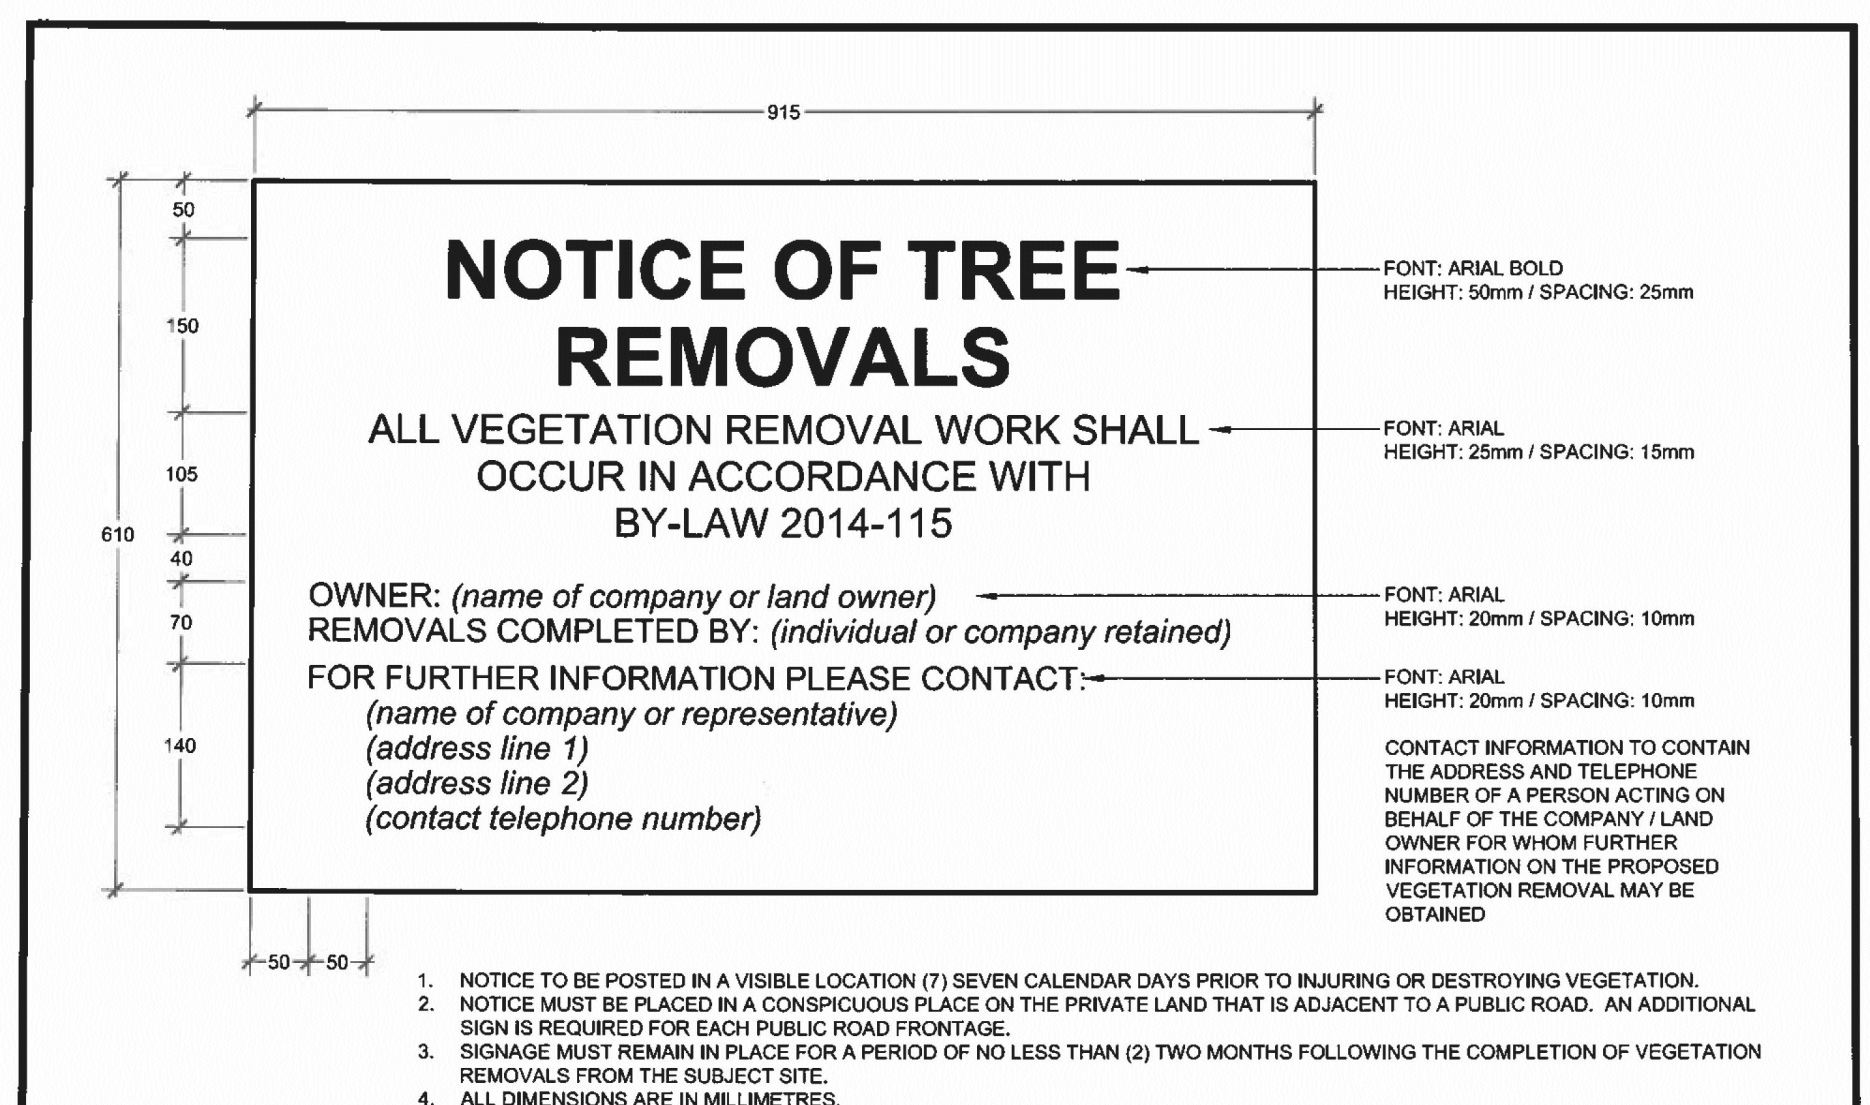

1. NOTICE TO BE POSTED IN A VISIBLE LOCATION (1) SEVEN CALENDAR DAY'S PRIOR TO INJURING OR DESTROYING VEGETATION.
2. NOTICE MUST BE PLACED IN A CONSPICUOUS PLACE ON THE PRIVATE LAND THAT IS ADJACENT TO A PUBLIC ROAD. AN ADDITIONAL SIGN IS REQUIRED FOR EACH PUBLIC ROAD FRONTAGE.
3. SIGNAGE MUST REMAIN IN PLACE FOR A PERIOD OF NO LESS THAN (2) TWO MONTHS FOLLOWING THE COMPLETION OF VEGETATION REMOVALS FROM THE SUBJECT SITE.
4. ALL DIMENSIONS ARE IN MILLIMETRES.

<p>STANDARD DETAIL</p>	<p>TREE REMOVAL NOTIFICATION TEMPLATE</p>	REV No. 1 DATE: JUNE 2015 SCALE: N.T.S.	APPROVED DATE: June 11, 2015 DIRECTOR OF ENGINEERING
		BSD-1230	
		DIRECTOR OF ENGINEERING	

1 TP-2 TREE PROTECTION FENCING

GENERAL NOTES

1. Do not scale the drawings. All dimensions are in millimetres unless noted otherwise.
2. This drawing is to be read in conjunction with the project site plan, landscape plan, and engineering plan.
3. The tree inventory includes assessment of trees >10cm DBH. The trees have been assessed based on species, size and condition.
4. The contractor shall check and verify all existing and proposed grading and conditions on the project and immediately report any discrepancies to the consultant before proceeding with any removals.
5. The contractor is to be aware of all existing and proposed services and utilities. The contractor is responsible for having all underground services and utility lines staked by each agency having jurisdiction prior to commencing work.
6. This drawing is to be used for development approval only.
7. Do not leave any holes open overnight.
8. Keep area outside construction zone clean and useable by others at all times. Contractor shall thoroughly clean areas surrounding the construction zone at the end of each work day.
9. Contractor to make good any and all damages outside of the development area that may occur as a result of tree removals at no extra cost.
10. This drawing is Copyright MHBC Planning, 2021.

2.	FEBRUARY 11 2022	ISSUED FOR SPA	CC
1.	DECEMBER 15 2021	ISSUED FOR REVIEW	CC
REVISION NO.	DATE	ISSUED / REVISION	BY

230-7050 WESTON ROAD WOODBRIDGE, ON, L4L 8G7 | P: 905.761.5589 F: 905.761.5589 | WWW.MHBCPLAN.COM

STAMP 	DATE JANUARY 2022
	DRAWN BY CC
PLAN SCALE 1:400	
FILE NO. 1219J	
CITY PROJECT NUMBER D28-095-2021	
CLIENT NAME LOON AVENUE LANDS OP INC.	
PROJECT LOON LANDS BARRIE, ON	
LEGAL DESCRIPTION PT S 1/2 LT 11 CON 12 INNISFIL PT 1 51R4733 EXCEPT PT 1 EXPRO. PL SC944619; CITY OF BARRIE	
FILE NAME TREE PROTECTION PLAN / EDGE MANAGEMENT PLAN	DWG NO. TP-2
SOURCE N:\219\1 - Loon Lands\2. Drawings\3. Arborist\3. 02-09-2022\1219J - Tree Protection - 02-09-2022.dwg	