



NOTE:
REFER TO L2 FOR TREE INVENTORY NOTES AND TREE PROTECTION DETAILS.

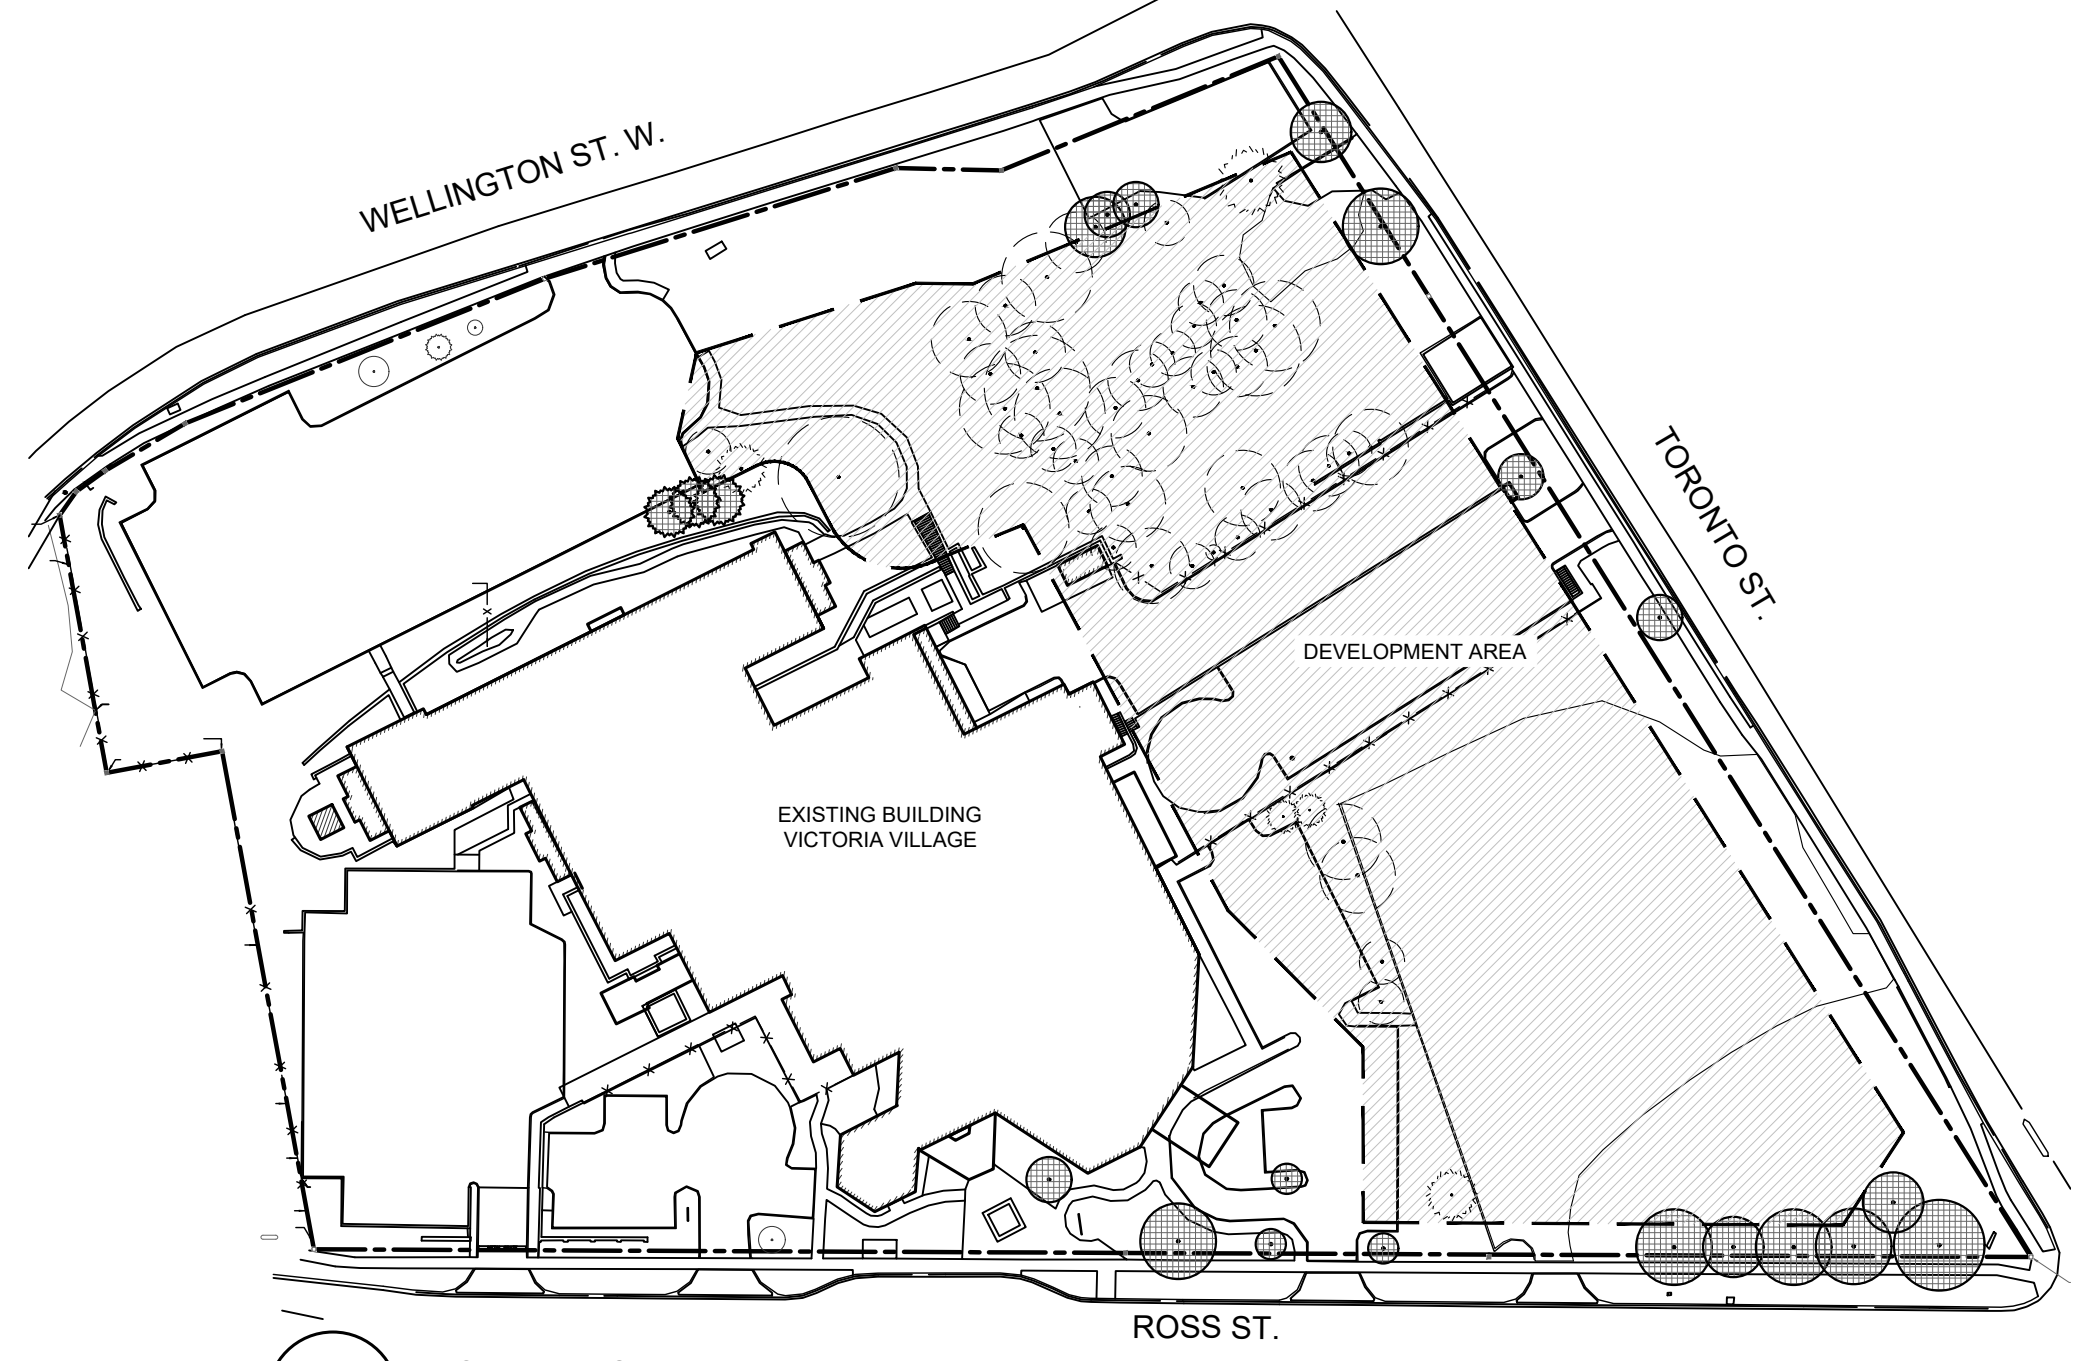


1 OVERALL SITE LAYOUT
1:1000

| LEGEND | |
|--------|---|
| | EXISTING INVENTORIED TREES TO REMAIN |
| | EXISTING TREES TO REMAIN NOT IMPACTED BY PROPOSED DEVELOPMENT |
| | EXISTING INVENTORIED TREES TO BE REMOVED |
| | TREE PROTECTION FENCE |

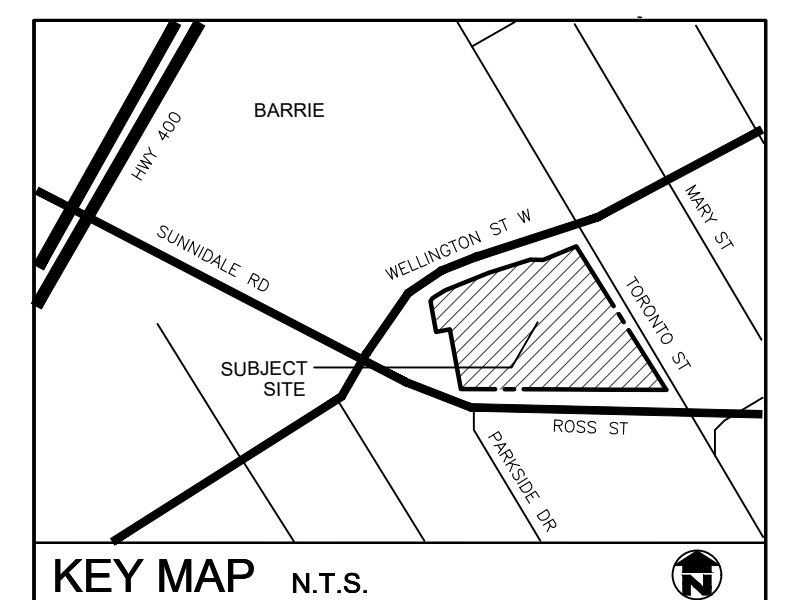

- GENERAL NOTES**
1. CONTRACTOR TO LOCATE ALL UNDERGROUND UTILITIES.
 2. EXISTING CONDITIONS PLAN AS PER RUDY MAK SURVEYING LTD.
 3. SITE PLAN INFORMATION AS PER SALTOR PILON ARCHITECTURE.

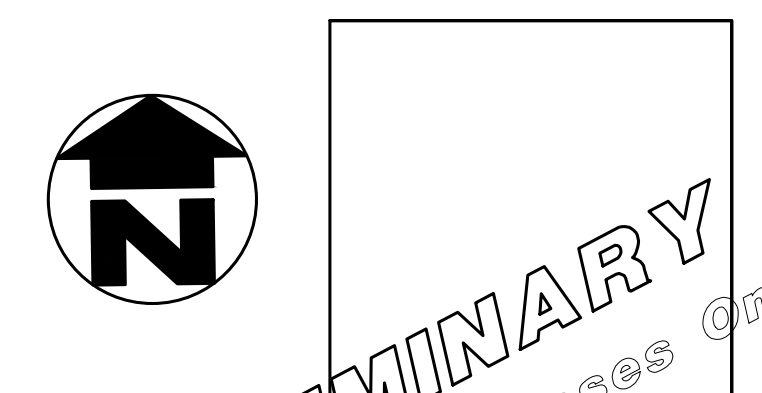

| REVISIONS | | |
|-----------|----------|-----|
| no. | date | by |
| 1. | xx.xx.22 | xxx |

VICTORIA VILLAGE
PROPOSED DEVELOPMENT
150 Toronto St. & 54 Ross St.
City of Barrie

Tree Management Plan



| | |
|---------------------|--------------------------|
| PROJECT NO: 2022-63 | DRAWN BY: CMH |
| SCALE: 1:300 | DESIGNED BY: CMH |
| SHEET: | APPROVED BY: xxx |
| L1 | PLOT DATE: OCT. 26, 2022 |


NOTES:

SITE VISIT DATE: OCTOBER 6, 2022
 TREE INVENTORY COMPLETED BY ISA CERTIFIED ARBORIST CATHERINE HODGINS #0N-2258A
 TREE LOCATIONS AND DRIFLINES BASED ON RUDY MAK SURVEYING LTD. SURVEYOR'S REAL PROPERTY REPORT DATED SEPTEMBER 20, 2022 AND HILL DESIGN STUDIO FIELD SURVEY ON OCTOBER 6, 2022.
 NA DENOTES APPROXIMATE LOCATION OF TREE BASED ON HILL DESIGN STUDIO FIELD SURVEY.


| ID # | Tree Species | D.B.H (cm) | Condition | Status | Comments |
|------|------------------------------------|----------------------|-----------|----------|-------------------------------------|
| 1 | Acer platanoides | 18 | Good | Remove | |
| 2 | Acer platanoides | 18 | Good | Remove | |
| 3 | Acer platanoides | 18/20/22/24 | Good | Remove | |
| 4 | Acer platanoides | 42 | Fair | Remove | Leaning, trunk issues |
| 5 | Picea glauca | 16 | Fair | Remove | Limbed up |
| 6 | Picea glauca | 18 | Fair | Remove | Limbed up, thin crown |
| 7 | Gleditsia triacanthos var. enermis | 50 | Good | Preserve | |
| 8 | Gleditsia triacanthos var. enermis | 44 | Good | Preserve | |
| 9 | Gleditsia triacanthos var. enermis | 46 | Good | Preserve | |
| 10 | Gleditsia triacanthos var. enermis | 50 | Good | Preserve | |
| 11 | Gleditsia triacanthos var. enermis | 60 | Good | Preserve | |
| 12 | Acer platanoides | 20 | Good | Preserve | Memorial tree |
| 13 | Acer platanoides | 32 | Fair | Preserve | In hydro lines, twist in trunk |
| 14 | Acer platanoides | 17 | Fair | Preserve | 10% dieback |
| 15 | Gleditsia triacanthos var. enermis | 21 | Good | Remove | |
| 16 | Acer negundo | 50/60 | Fair | Remove | 1 trunk gone |
| 17 | Gleditsia triacanthos var. enermis | 46 | Good | Preserve | Leaning into site |
| 18 | Acer platanoides | 18/20/22 | Good | Preserve | |
| 19 | Acer platanoides | 60 | Fair | Remove | 50% dead |
| 20 | Acer saccharum | 15 | Good | Remove | |
| 21 | Picea pungens | 20 | Good | Remove | |
| 22 | Picea pungens | 18 | Good | Preserve | |
| 23 | Picea pungens | 20 | Good | Preserve | |
| 24 | Picea pungens | 22 | Good | Preserve | |
| 149 | Syringa reticulata | 10 | Poor | Preserve | 75% dead |
| 150 | Picea pungens | 27 | Good | Remove | |
| 151 | Syringa reticulata | 10 | Good | Preserve | |
| 152 | Syringa reticulata | 10 | Fair | Preserve | Trunk crack |
| 153 | Gleditsia triacanthos var. enermis | 38 | Good | Preserve | |
| 154A | Prunus sp. | 20 | Good | Preserve | |
| 155 | Ulmus pumila | 35/35/27 | Good | Remove | |
| 156A | Acer negundo | 18 | Fair | Remove | |
| 157A | Acer negundo | 22/20 | Fair | Remove | |
| 158A | Acer negundo | 20/15 | Fair | Remove | |
| 159A | Picea glauca | 40 | Fair | Remove | |
| 160A | Acer platanoides | 38 | Fair | Remove | Suppressed, leader broken |
| 161A | Ulmus pumila | 40 | Fair | Remove | |
| 162A | Ulmus pumila | 40 | Very Poor | Remove | 95% dead |
| 163A | Ulmus pumila | 25/25 | Poor | Remove | 80% dead |
| 164A | Acer platanoides | 20 | Fair | Remove | Suppressed |
| 165A | Juglans nigra | 50 | Good | Remove | |
| 166A | Acer platanoides | 30 | Fair | Remove | |
| 167A | Acer platanoides | 10/10/12 | Fair | Remove | |
| 168A | Acer saccharum | 20 | Good | Remove | |
| 169A | Acer platanoides | 28 | Fair | Remove | Suppressed |
| 170A | Acer platanoides | 38/18/34 | Good | Remove | |
| 171A | Acer platanoides | 24 | Fair | Remove | Suppressed |
| 172A | Acer platanoides | 10/10/22/12/26 | Fair | Remove | Exposed roots |
| 173A | Acer platanoides | 48 | Good | Remove | |
| 174A | Morus alba | 22 | Fair | Remove | Leaning, roots heaving |
| 175A | Fraxinus sp. | 12/22/22/25/21 | Dead | Remove | Evidence of E.A.B. |
| 176A | Acer platanoides | 30 | Good | Remove | Leaning away from tree stand |
| 177A | Acer saccharum | 14/22 | Good | Remove | |
| 178A | Acer saccharum | 12/12/10/14/22/15/12 | Good | Remove | |
| 179A | Acer platanoides | 25/25/18/18 | Good | Remove | |
| 180A | Acer platanoides | 20/20/11/11 | Good | Preserve | |
| 181A | Aesculus hippocastanum | 36/36 | Fair | Remove | Leaning |
| 182A | Acer platanoides | 22 | Fair | Remove | Suppressed |
| 183A | Acer platanoides | 26 | Fair | Remove | Suppressed |
| 184A | Acer platanoides | 22 | Fair | Remove | Suppressed |
| 185A | Fraxinus sp. | 22 | Poor | Remove | Evidence of E.A.B., horizontal lean |
| 186A | Acer platanoides | 25 | Fair | Remove | |
| 187A | Acer platanoides | 11 | Good | Remove | |
| 188A | Acer platanoides | 14 | Good | Remove | |
| 189A | Acer platanoides | 22/11 | Good | Remove | Suppressed |
| 190A | Acer platanoides | 12 | Fair | Remove | Suppressed |
| 191A | Juglans nigra | 24 | Fair | Remove | Suppressed |
| 192A | Juglans nigra | 26 | Fair | Remove | Suppressed |
| 193A | Juglans nigra | 40/40 | Fair | Remove | Broken limb |
| 194A | Juglans nigra | 30/32 | Good | Remove | |
| 195A | Juglans nigra | 12/12 | Fair | Preserve | Suppressed |
| 196A | Juglans nigra | 11/11 | Fair | Preserve | Suppressed |
| 197A | Acer saccharum | 10/10 | Fair | Remove | Suppressed |
| 198A | Thuja occidentalis | 52/20/12 | Fair | Remove | Leaning, trunk wound |

TREE PROTECTION NOTES

- AS PART OF ANY TREE REMOVAL OPERATION ALL STEMS, LIMBS AND STUMPS SHOULD BE REMOVED FROM THE SITE.
- UPON COMPLETION OF ANY TREE REMOVAL OPERATIONS, TREE PROTECTION FENCING SHOULD BE INSTALLED AS ILLUSTRATED. THIS PROTECTION FENCING SHOULD BE MAINTAINED UNTIL ALL EXCAVATION AND BUILDING CONSTRUCTION WORK IS COMPLETED.
- ANY ROOTS DISTURBED DURING CONSTRUCTION SHOULD BE CUT CLEANLY AND BURIED IMMEDIATELY.
- NO HEAVY EQUIPMENT OR STOCKING OF MATERIAL SHALL OCCUR WITHIN THE DRIFLINES OF ANY TREES THAT ARE TO BE PRESERVED.
- TREE PROTECTION MEASURES TO BE INSPECTED BY LANDSCAPE ARCHITECT AND CITY STAFF PRIOR TO START OF CONSTRUCTION.
- IF CONSTRUCTION OR ANY WORK OCCURS WITHIN THE TREE PRESERVATION ZONE, INSIDE THE LIMITS OF THE TREE PROTECTION FENCE, IT IS NECESSARY TO ONLY USE HAND TOOLS. NO MACHINERY WILL BE PERMITTED IN THIS ZONE.

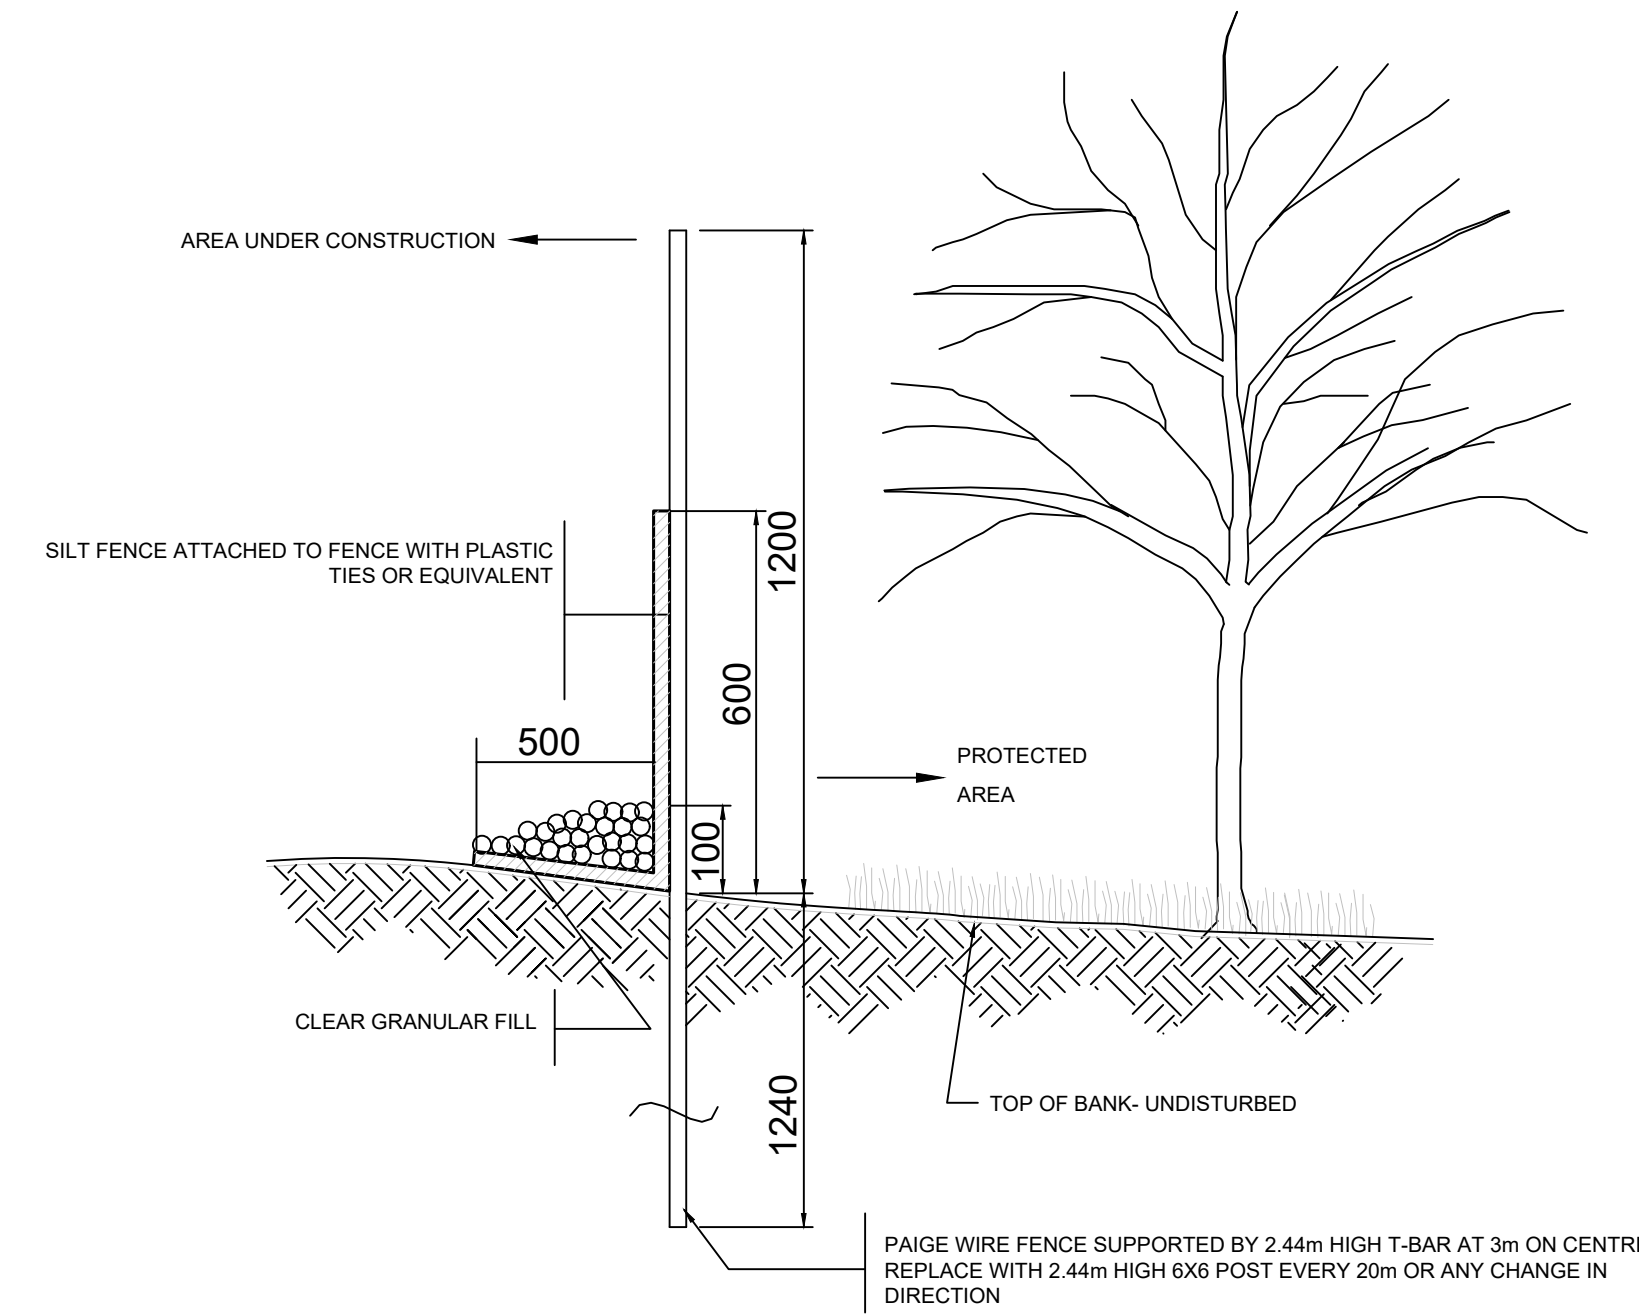


1 TREE PROTECTION FENCING DETAIL
 NTS

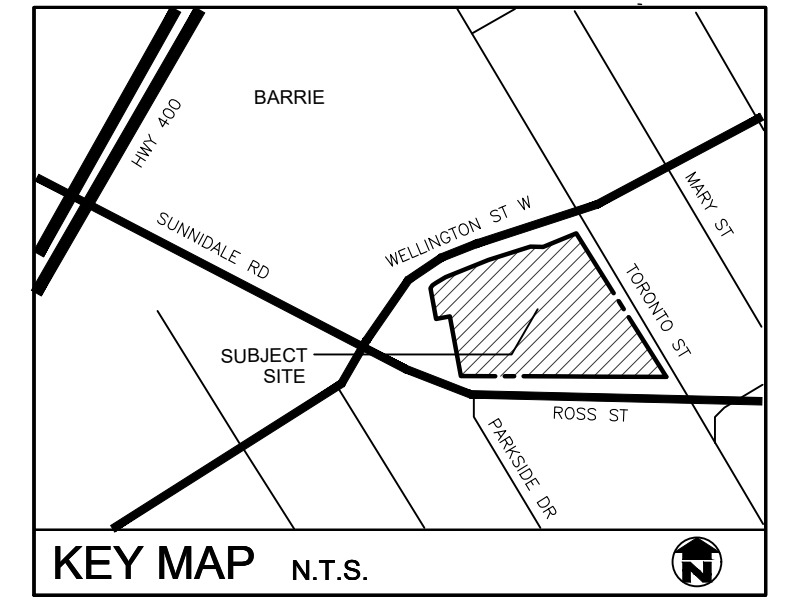

GENERAL NOTES

- CONTRACTOR TO LOCATE ALL UNDERGROUND UTILITIES.
- EXISTING CONDITIONS PLAN AS PER RUDY MAK SURVEYING LTD.
- SITE PLAN INFORMATION AS PER SALTOR PILON ARCHITECTURE.

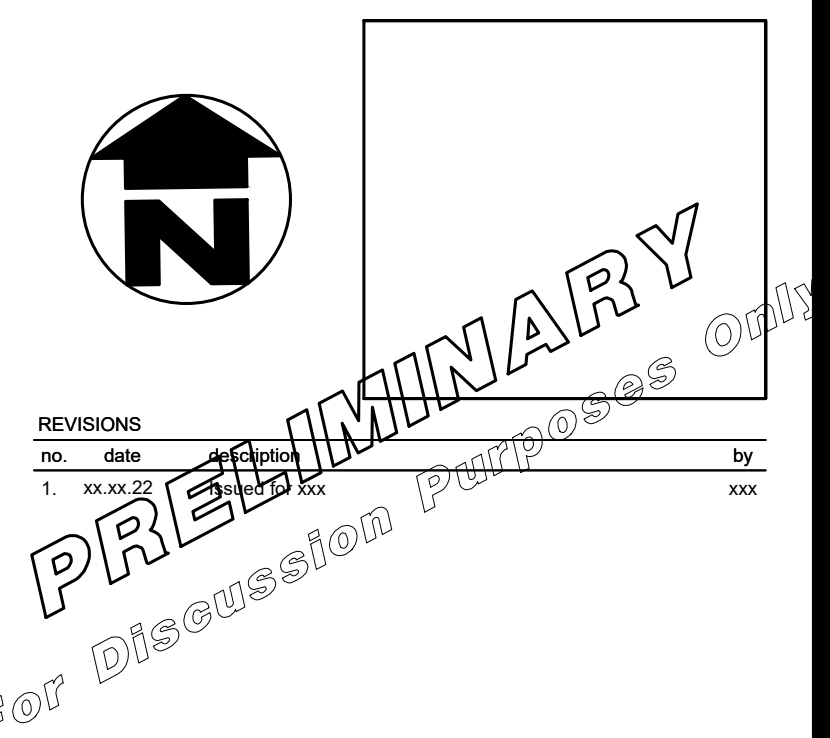

| no. | date | by |
|-----|----------|-----|
| 1. | xx.xx.22 | xxx |

VICTORIA VILLAGE
 PROPOSED DEVELOPMENT
 150 Toronto St. & 54 Ross St.
 City of Barrie

Tree Management Details



| | |
|----------------------|--------------------------|
| PROJECT NO.: 2022-63 | DRAWN BY: CMH |
| SCALE: N.T.S. | DESIGNED BY: CMH |
| SHEET: | APPROVED BY: xxx |
| L2 | PLOT DATE: OCT. 26, 2022 |